
ROOM	ROOM AREA	MINDOM TYPE	LIGHT AREA REQ.	VENT AREA REQ.	ACTUAL LIGHT AREA	ACTUAL VENT AREA	TEMPERED	BEDROOM EGRESS AREA
GREAT ROOM / KITCHEN CASUAL DINING	766.92 S.F.	(5)-3660+3660-2 +(10)-3624TR+DR	61.35 S.F.	30.67 S.F.	80.50 S.F. + TR	40.18 S.F. + DR		
BEDROOM #1	226.33 S.F.	(3)-3660+(3)-3624TR	18.10 S.F.	9.0 5 S.F.	34.50 S.F.	17.22 S.F.		5.74 S.F.
BATH #1	100.86 S.F.	3624-2TR	8.06 S.F.	4.03 S.F.	TRANSOM + ARTIFICAL	MECH.		
BEDROOM #2	155.83 S.F.	3672	12.46 S.F.	6.23 S.F.	14.07 S.F.	6.82 S.F.		6.82 S.F.
BATH #2	57.71 S.F.		4.61 S.F.	2.30 S.F.	ARTIFICAL	MECH.		
LAUNDRY	56.60 S.F.		4.52 S.F.	2.26 S.F.	ARTIFICAL	MECH.		
BEDROOM #3	210.53 S.F.	3660	16.84 S.F.	8.42 S.F.	11.50 S.F. + ARTIFICAL	5.74 S.F. + MECH.		5.74 S.F.
BATH #3	44.75 S.F.		3.58 S.F.	1.79 S.F.	ARTIFICAL	MECH.		
RECREATION ROOM	428.44 S.F.	(2)-3660+3660-2	34.27 S.F.	17.13 S.F.	46.00 S.F.	22.96 S.F. + DOOR		

ARTIFICAL LIGHT AND MECHANICAL VENTILATION TO COMPLY WITH 2013 RCO SECTION 303.

Lot 4 Britonwood - Spec. Residence 7221 Craigens Court Alexandria3.0

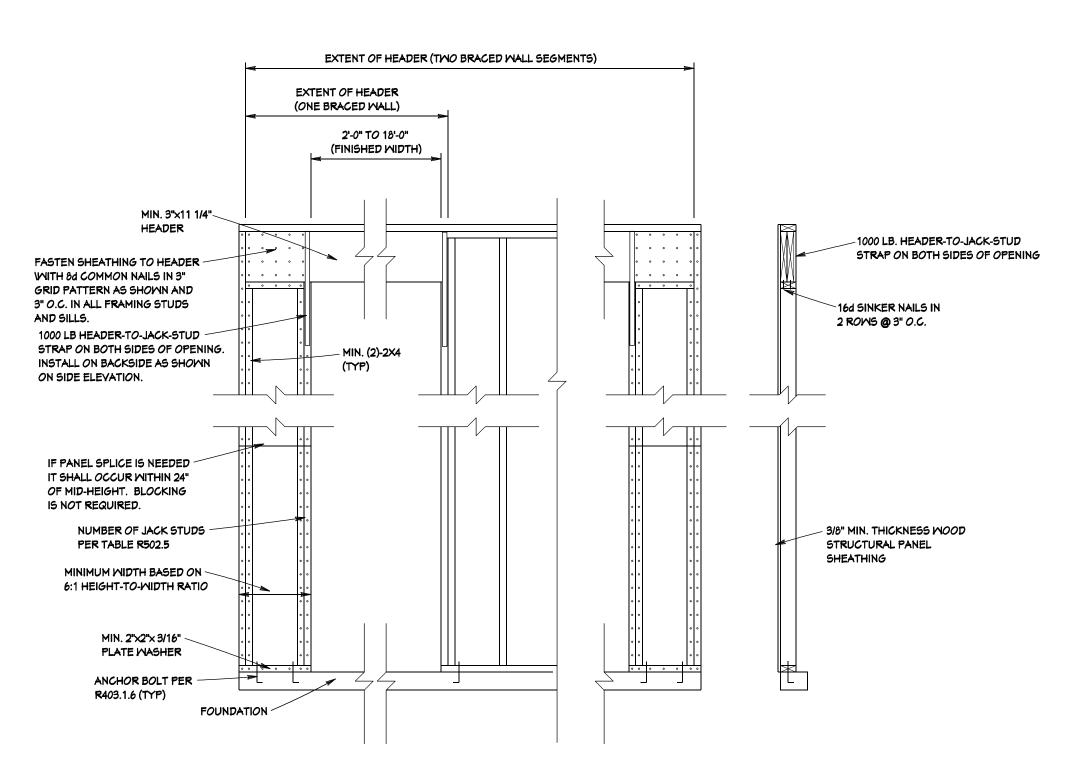

"APA" NARROW WALL BRACING DETAIL

		ROOF ATTIC VENTILATION				
<u>, </u>		SQ.FT. ATTIC SPACE	2808.61 SQ.FT.			
	I	SQ.IN. YENTILATION REQ'D.	1349.00 SQ.IN.			
	I	SQ.IN. YENTILATION SUPPLIED = 2448.00 SQ. IN.				
	I	80 LIN. FT. OF RIDGE VENT @ 18.00 SQ. IN./LIN. FT. = 1440.00 SQ.IN.				
24-16x6 SOFFIT VENTS @ 42.00 SQ. IN. EACH = 1008.00 SQ.IN.						
	I					

CLIMATIC AND GEOGRAPHIC DESIGN CRITERIA (2013 RCO TABLE 301.2 (1)) MIND DESIGN SUBJECT TO DAMAGE FROM GROUND SNOW SEISMIC ICE SHIELD UNDERLAYMENT FREEZING DESIGN DESIGN ACTUAL HAZARDS TOPOGRAPHIC CATEGORY MEATHERING TEMP. REQUIRED INDEX TEMP. TERMITE SPEED FROST DEPTH **EFFECTS** MODERATE TO 90 MPH NO SEYERE 5 DEG. F YES 1500 50.1 DEG. F HEAVY B. 4/22/97

CODE NOTES

- 1) THE GARAGE SHALL BE COMPLETELY SEPARATED FROM THE RESIDENCE AND ITS ATTIC AREA BY MEANS OF A (1) ONE HOUR FIRE-RATED WALLS AND CEILINGS.
- 2) WHEN THE BASEMENT STAIR IS ENCLOSED AND THE UNDERSIDE IS ACCESSIBLE FOR STORAGE, THEN THE BOTTOM OF THE STAIR STRINGER SHALL BE FIRESTOPPED AND THE UNDERSIDE MUST BE COMPLETELY DRYWALLED.
- HANDRAILS SHALL BE PROVIDED ON AT LEAST ONE SIDE OF THE STAIRS WITH 3 OR MORE RISERS. HANDRAILS WILL BE MEASURED BETWEEN 34 TO 38 INCHES VERTICALLY FROM THE NOSING OF THE TREADS. THE HANDGRIP PORTION SHALL NOT BE MORE THAN 20" IN CROSS SECTION DIMENSION OR AN APPROPIATE SHAPE WHICH SHALL PROVIDE AN EQUIVALENT GRIPPING SURFACE. THE HANDGRIP PORTION OF HANDRAILS SHALL HAVE A SMOOTH SURFACE MITH NO SHARP EDGES.
- PORCHES, BALCONIES OR RAISED FLOORS LOCATED MORE THAN 30" ABOVE THE FLOOR OR GRADE SHALL HAVE GUARDRAILS NOT LESS THAN 36" HIGH. OPEN STAIRS WITH A RISE OF MORE THAN 30" SHALL HAVE GUARDRAILS NOT LESS THAN 34" HIGH. DISTANCE BETWEEN BALUSTERS TO BE LESS THAN 4".
- SMOKE DETECTORS SHALL BE INSTALLED IN ALL SLEEPING ROOMS, AREA OUTSIDE AND ADJACENT WITHIN 15 FEET TO SLEEPING AREA ON EACH STORY INCLUDING BASEMENT AND CELLARS AND ALL DETECTORS SHALL BE INTERCONNECTED. REQUIRED SMOKE DETECTORS PRIMARY POWER SHALL BE FROM THE BUILDING WIRING AND WHEN THE PRIMARY POWER IS INTERRUPTED, SHALL RECEIVE POWER FROM A BATTERY. ROOMS WITH SLOPED CEILINGS THAT MUST HAVE SMOKE DETECTORS INSTALLED. THE LOCATION OF THE SMOKE DETECTOR SHALL BE 3 FEET HORIZONTALLY FROM THE CEILING HIGHEST POINT.
- 6) THE GRADE AWAY FROM FOUNDATION WALLS SHALL FALL A MIN. 6" WITHIN THE FIRST 10'.
- CONCRETE SLABS IN BASEMENT SHALL BE 2500 PSI AND GARAGE SHALL BE 3500 PSI, AND BOTH SHALL BE AIR ENTRAINED CONCRETE WITH VAPORBARRIER OVER BASE COURSE IN ACCORDANCE WITH CABO TABLE 402.2. ALL CONCRETE SLABS ON GRADE WITH HABITABLE SPACES SHALL HAVE A VAPORBARRIER OVER THE BASE COURSE.
- ANCHOR BOLTS MUST BE IMBEDDED 15" INTO CONCRETE BLOCK AND IMBEDDED 1" INTO POURED CONCRETE, BOLTS SHALL BE SPACED 6' ON CENTER, 12" FROM CORNERS. ANCHOR STRAPS MUST BE INSTALLED PER MANUFACTURER'S SPECS.
- 4) 2x BLOCKING EQUAL TO THE JOIST DEPTH TO BE INSTALLED AT 24" O.C. BETWEEN THE BAND AND FIRST JOIST WHICH IS PARALLEL TO THE FOUNDATION WALL. BLOCKING SHALL BE ADEQUATELY FASTEN TO THE FLOOR SHEATHING.
- 10) UNDERFLOOR SPACES SHALL BE PROVIDED WITH 1 CFM OF AIR EXCHANGE PER EVERY 50 SQ. FT. OF CRAWLSPACE WHEN INSULATING THE CRAWLSPACE WALLS. EXTERIOR WALL VENTS MUST BE INSTALLED PER CABO AND ONLY WHEN INSULATING
- 11) JOISTS UNDER PARALLEL BEARING PATTITIONS SHALL BE DOUBLED OR A BEAM OF ADEQUATE SIZE TO SUPPORT THE LOAD SHALL BE PROVIDED.
- 12) ENDS OF JOIST, BEAM OR GIRDER TO BEAR 1♦" OR GREATER ON WOOD OR METAL AND TO BEAR 3" OR GREATER ON MASONRY.
- 13) FIRESTOPPING SHALL BE PROVIDED TO CUT OFF ALL CONCEALED DRAFT OPENINGS (VERT. AND HORIZ.) AND TO FORM AN EFFECTIVE FIRE BARRIER BETWEEN STORIES AND BETWEEN STORIES AND THE ROOF.
- 14) MAINTAIN A MIN. 2" AIR SPACE BETWEEN CHIMNEY AND THE INTERIOR AND MAINTAIN A MIN. OF 1" SPACE BETWEEN THE CHIMNEY AND THE
- 15) CHIMNEYS ARE TO EXTEND TO 2'-0" OR GREATER ABOVE HIGHEST PORTION OF THE BUILDING WITHIN 10'-0" AND SHALL BE 3'-0" OR GREATER ABOVE ITS ROOF PENETRATION.
- 16) FACTORY BUILT FIREPLACES SHALL COMPLY WITH LISTINGS AND SPECIFICATIONS OF MANUFACTURER AND/OR THE LATEST EDITION OF NFPA 211.
- 17) MASONRY AND FACTORY BUILT FIREPLACES SHALL BE EQUIPPED WITH AN EXTERIOR AIR SUPPLY TO ASSURE PROPER FUEL COMBUSTION.
- 18) INSULATION AND FACINGS EXPOSED IN ATTIC, DWELLING UNIT OR CRAWL SPACES SHALL HAVE A FLAME SPREAD RATING NOT TO EXCEED 25 AND SMOKE DEVELOPED FACTOR NOT TO EXCEED 450.
- 14) IN ALL FRAME WALLS AND FLOORS, AND CEILINGS, NOT VENTILATED TO ALLOW MOISTURE TO ESCAPE, AN APPROVED VAPOR RETARDER HAVING A MAXIMUM PERM RATING OF 1.0, SHALL BE INSTALLED ON THE WARM-IN-WINTER SIDE OF THE THERMAL INSULATION.
- 20) 18" CLEARANCE SHALL BE MAINTAINED BELOW FLOOR JOISTS OVER EXPOSED EARTH IN CRAWL SPACE. VAPOR BARRIER MUST BE APPLIED OVER THE SOIL.
- 21) PROVIDE ACCESS TO ALL SHUT OFFS, UNIONS AND CONNECTIONS.

GENERAL NOTES

- 1) EXTERIOR DIMENSIONS ARE FROM OUT TO OUT OF SHEATHING.
- 2) INTERIOR DIMENSIONS ARE FROM FACE TO FACE OF FRAMING.
- 3) ALL INTERIOR PARTITIONS ARE 2x4 (3◊") UNLESS OTHERWISE NOTED.

4)	LIVE/DEAD	FOOTINGS	1500 PS
	LOADS	FIRST FLOOR	50 PSF
		SECOND FLOOR	50 PSF
		ROOF WICEILING	30 PSF
		ROOF WO CEILING	20 PSF

5) LUMBER GRADES UNLESS OTHERWISE SPECIFIED ALL WOOD FRAMING SHALL HAVE THE FOLLOWING

DECKS

50 PSF

MINIMUM VALUES: UP TO 2x4 Fb = 1509 (REPETITIVE) (#2 SPF) Fb = 1308 (REPETITIVE) 2×8 Fb = 1208 (REPETITIVE)

2×10 Fb = 1107 (REPETITIVE) 2×12 Fb = 1006 (REPETITIVE) (#2 SYP) E = 1.6Fb = 1725 (REPETITIVE) UP TO 2×4

Fb = 1440 (REPETITIVE) Fb = 1380 (REPETITIVE) Fb = 1208 (REPETITIVE) Fb = 1120 (REPETITIVE) "LYL" LUMBER AS MANUFACTURED Fb = 2600BY TRUSS-JOIST

Fv = 285

PROVIDE 7/16 " OSB. AT INSIDE AND OUTSIDE BUILDING CORNERS 4'-0" WIDE. TYPICAL FULL HEIGHT OF WALL w/8d @ 6" O.C. AT PANEL CORNERS & EDGES w/8d @ 12" O.C. AT INTERMEDIATE STUDS

MINDOMS ARE VINYL SINGLE HUNG.

OR EQUAL

- PROVIDE DOUBLE STUDS AT ALL LINTEL AND WOOD BEAM BEARINGS UNLESS NOTED OTHERWISE.
- 9) ALL MULTIPLE STUDS AT BEAM BEARING MUST BE #2 SPF OR BETTER. NAIL TOGETHER WITH
- 10) PROVIDE SOLID BLOCKING BELOW ALL MULTIPLE STUDS.
- 11) MULTIPLE MEMBER BEAMS NAIL TOGETHER WITH 2 ROWS 10d @ 12" O.C.
- 12) ALL FRAMING LUMBER #2 SPF OR BETTER EXCEPT ALL STUDS TO BE STUD GRADE LUMBER.
- 13) NAILING BASED ON COMMON NAIL SIZE, INCREASE 25% IF CEMENT COATED SINKERS OR NAIL GUNS ARE USED.
- 14) PROVIDE (2)-2x8 #2 SPF HEADERS AT EXTERIOR
- BEARING WALLS UNLESS NOTED OTHERWISE.
- 15) PROVIDE 1x2 "x" BRIDGING @ MIIDSPAN OF ALL
- PROVIDE ROOF SHEATHING AT TRUSS TOP CHORD AT ALL LOCATIONS FOR LATERAL SUPPORT OF TRUSS.
- 17) ALL LUMBER SHOULD BE GRADED AND MARKED WITH THE APPROPRIATE GRADE STAMP.

BUILDING AREAS

1979.05 SQ. FT. TOTAL BASEMENT FINISHED BASEMENT 1037.33 SQ. FT. UNFINISHED BASEMENT 941.72 SQ. FT. 1971.55 SQ. FT. FIRST FLOOR GARAGE 427.33 SQ. FT. FRONT PORCH COVERED PORCH

75.33 SQ. FT. 153.33 SQ. FT.

BASE LIVING AREA = 3008.88 SQ. FT.

FOUNDATION NOTES

- 1) ALL FOOTINGS ARE 16"x8" UNLESS OTHERWISE NOTED.
- ALL NON-BASEMENT FOOTINGS ARE 6'-0" ABOVE BASEMENT FOOTINGS. (TOP TO TOP)
- THICKENED TO 12" WITH 6" PROJECTION ON ALL SIDES.

MASONRY FIREPLACE FOOTINGS SHALL BE

- TO TIE POURED FOUNDATIONS OF DIFFERENT LEVELS, HOLD HIGH FOOTINGS BACK FROM LOWER EXCAVATIONS AND USE POURED LINTELS TO BRIDGE AND TIE.
- 5) ELEVATIONS BEGIN AT TOP OF BASEMENT FOOTING. (F=0'-0")
- ALL CROSSHATCHED POURED CONCRETE WALLS TOP OUT AT W=+10'-0" INCLUSIVE. ALL OTHER POURED CONCRETE WALLS TOP OUT AT ELEVATION SHOWN INCLUSIVE.
- 7) ALL FOOTING DESIGNS BASED ON 1500 PSF SOIL BEARING.
- 8) CRAWL SPACE IS MECHANICALLY VENTILATED AT A RATE OF 1 CFM FOR EACH 50 SF OF

SH. #

1A COVER SHEET

3 FIRST FLOOR PLAN

1B SPECIALTY DETAILS AND NOTES

2B BASE FINISHED BASEMENT PLAN

2A BASE FOUNDATION AND BASEMENT PLAN

EXTERIOR ELEVATIONS - FRONT

4B EXTERIOR ELEVATIONS - RIGHT SIDE

4D EXTERIOR ELEVATIONS - LEFT SIDE

F-2 FIRST FLOOR - FLOOR FRAMING PLAN

E-2 BASE BASEMENT ELECTRIC PLAN

E-3 FIRST FLOOR ELECTRIC PLAN

4C EXTERIOR ELEVATIONS - REAR

5 STAIR AND WALL SECTIONS

F-3 ROOF FRAMING PLAN

FLOOR AREA. 9) ALL METAL FASTENERS, CONNECTORS OR OTHER HARDWARE IN DIRECT CONTACT WITH ANY PRESERVATIVE TREATED LUMBER SHALL BE STAINLESS STEEL TYPE 304 OR TYPE 316 OR HAVE A GALVANIZED COATING THAT COMPLIES WITH THE ASTM A123 CONNECTORS OR A153 FASTENERS CLASS D

INDEX TO DRAWINGS

DESCRIPITION

Pataskala, Ohio 43062 STANDARDS FOR FASTENERS AND HARDWARE. THE CONNECTORS AND FASTENERS MUST BE MADE OF THE SAME MATERIAL FOR COMPATIBILTY.

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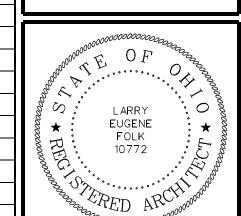
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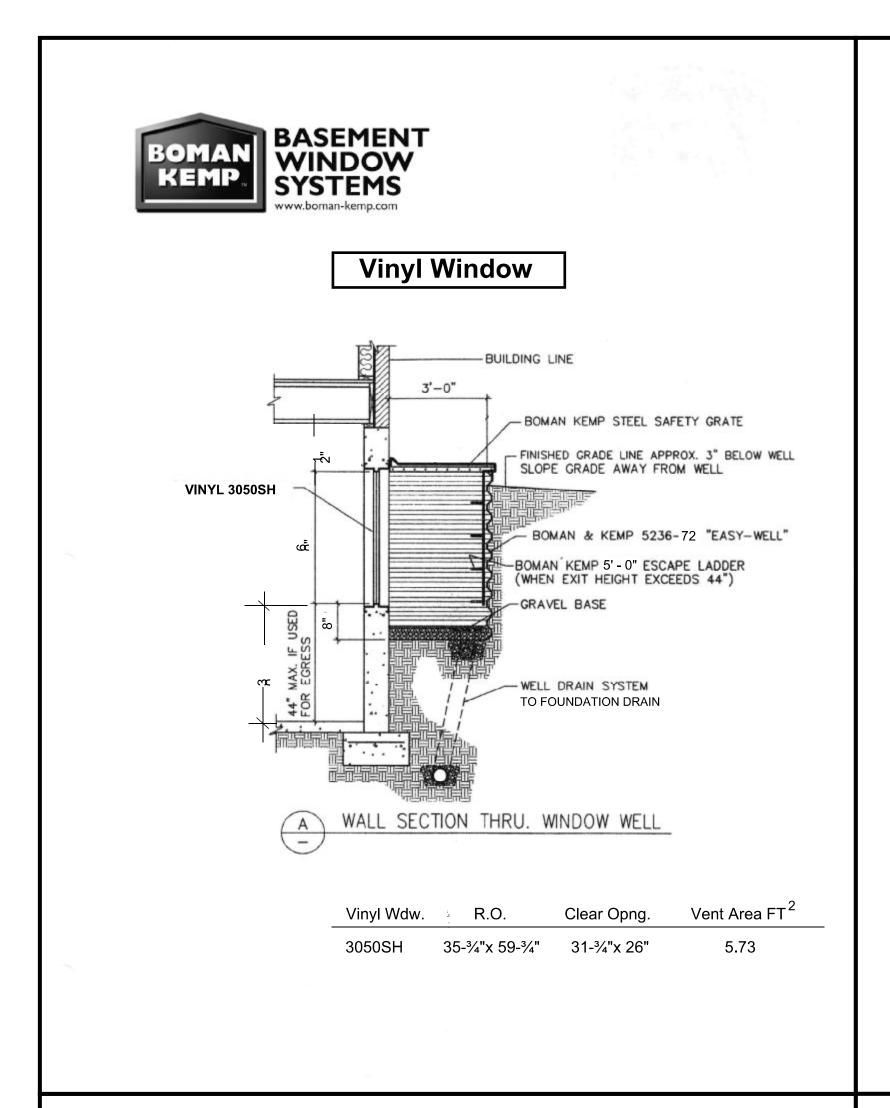
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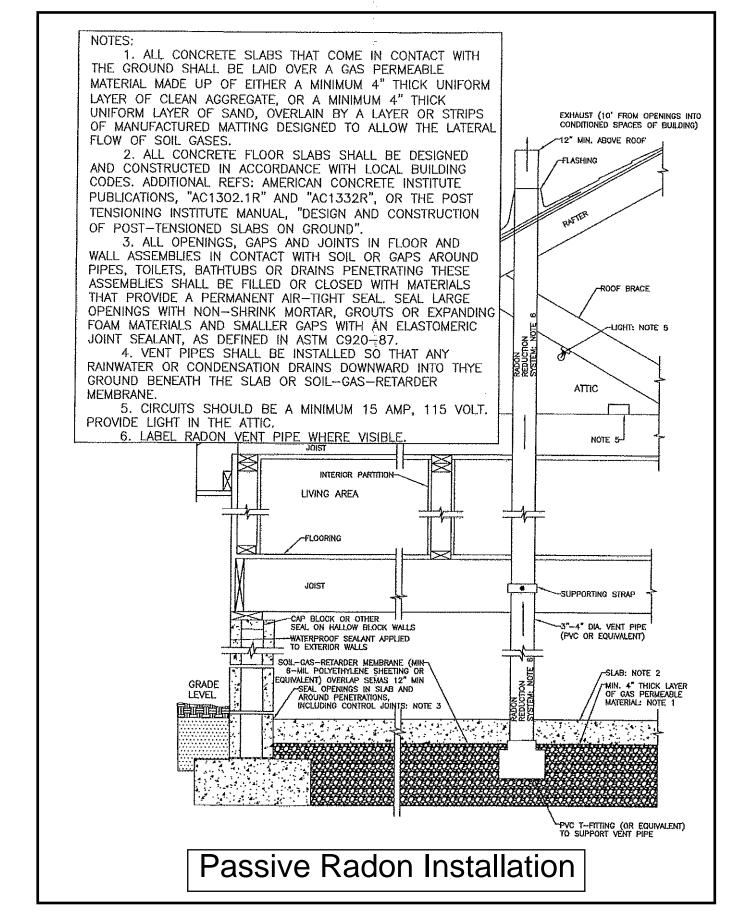



BOB WEBB

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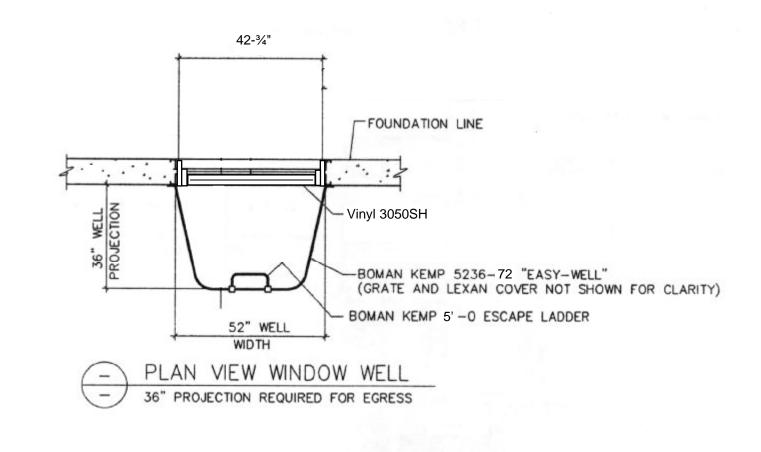
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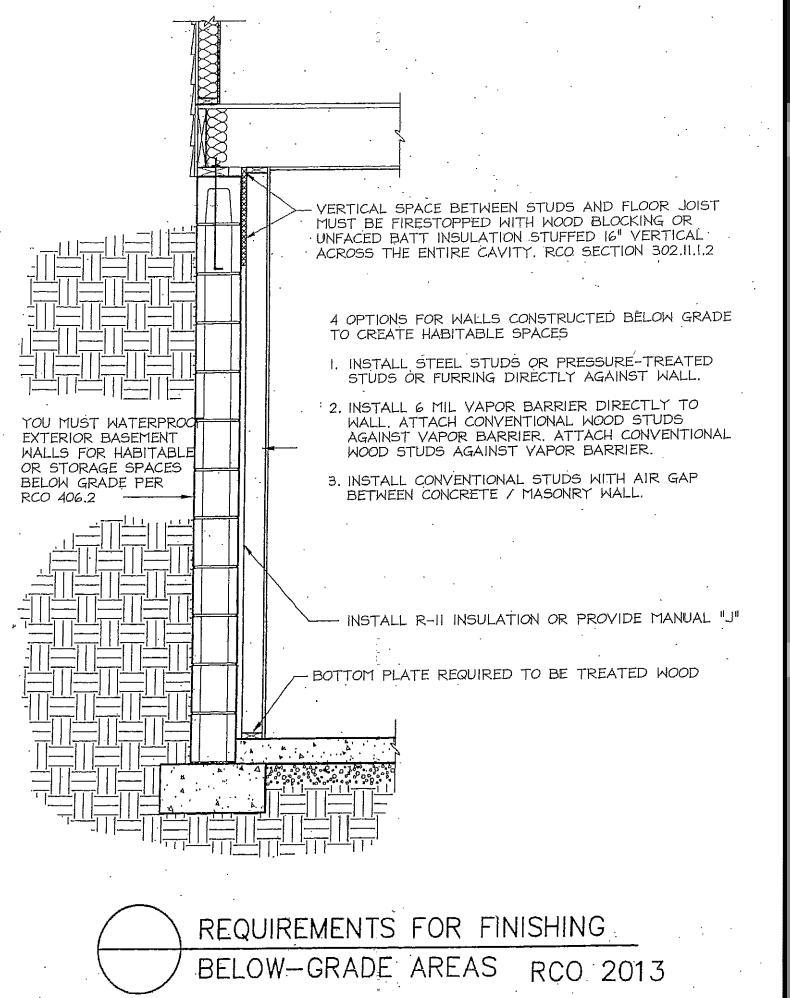








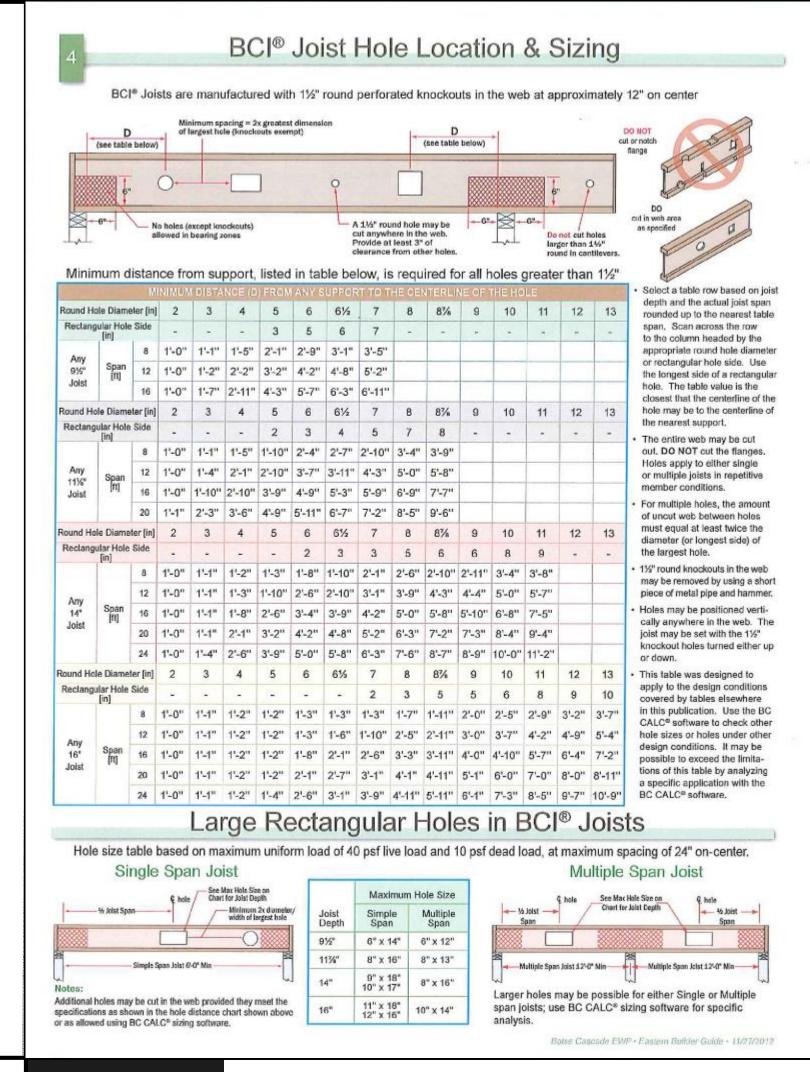





Tuff-N-Dry WaterProofing

Membrane Properties

Туре	Polymer-enhanced asphalt liquid-applied men	mbrane	
Colour	Black		
Solids	64% ± 3% (percent by weight)		
Density	8.2 ± .1 lbs/gal		
Application	Airless spray		
Application Temperature	Minimum -18°C (0°F)		
Application Thickness	60 mils (wet) ¹		
Cure Time	16–24 hrs (under normal conditions)		
Adhesion to Concrete (Peel, N/m)	Results: Exceeds	Method:	ASTM C-836
Elongation	Results: >2000%	Method:	ASTM D-412
Crack Bridging Ability	Results: Passes	Method:	ASTMC-836
Water Vapour Permeance	Results: <1 perm for 40-mil dry coating (grains/sf/hr)	Method:	ASTM E-96 Wet Method
Liquid Water Absorbtion	Results: 0.3% [wt]	Method:	ASTM E-1228 ²
Resistance to Degradation in Soil	Results: Good	Method:	ASTM E-154
Mould Growth and Bacterial Attack	Results: No Degradation	Methods:	ASTM D-3273 ASTM D-3274
Resistance to Hydrostatic Head [ft of water]	Results: Could not generate hydrostatic pressure	Method:	See ³

Resistance to Hydrostatic Head [ft of water] Results: Could not generate hydrostatic pressure Method: See³

1 Measured in place with an ASTM D-4414 notch film gauge. Wet film measuring 60 mils cures to 40 dry mils.

2 72 Hour water sook 1" x 2" x 0.40" samples of waterproofing compound.

When foundation board was applied to TUFF-N-DRI, the water drained away at a faster rate than the surrounding soil percolated, eliminating any hydrostatic build-up.

Board Properties

For more details on

visit our Web site at

TUFF-N-DRI.com.

WARM-N-DRI Foundation Board TUFF-N-DRI Barrier Board Board Size 4' x 8' 4' x 4' 4' x 8' 4' x 4' 3/4" 1-3/16" 2-3/8" 3/4" 1-3/16" 2-3/8" Drainage Ability hydraulic gradient of 1.0) Board Thickness 3/4" 1-3/16" 2-3/8" >70 >110 >210 Gallons/Hour/Lineal Foot⁴ >50 >80 >160 Thermal Resistance Board Thickness 3/4" 1-3/16" 2-3/8" 3/4" 1-3/16" 2-3/8" R-3 R-5 R-10 R-3⁵ R-5⁵ R-10⁵ Drainage rates with 10% board compression. At 65% compression, foundation board has the drainage capabilities of coarse sand.

TUFF-N-DRI®

istance values (R-value)


An RPPT company

Barrier Solutions

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 SCALE
 None
 No.
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 REVISIONS

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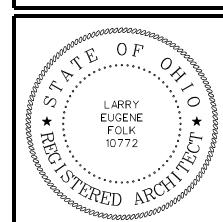
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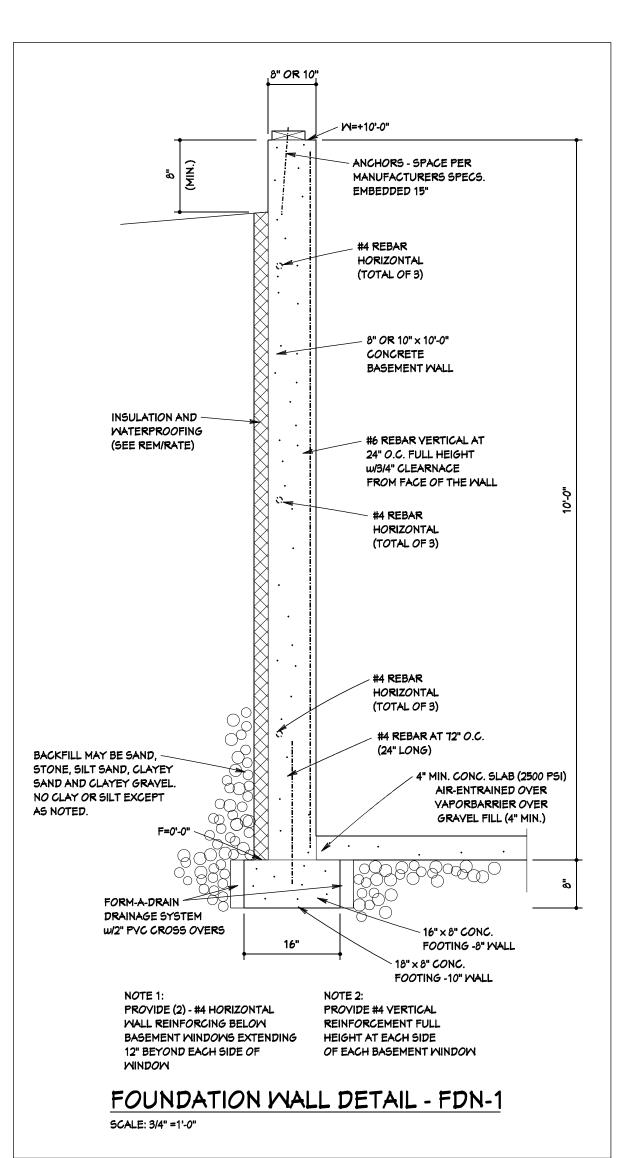



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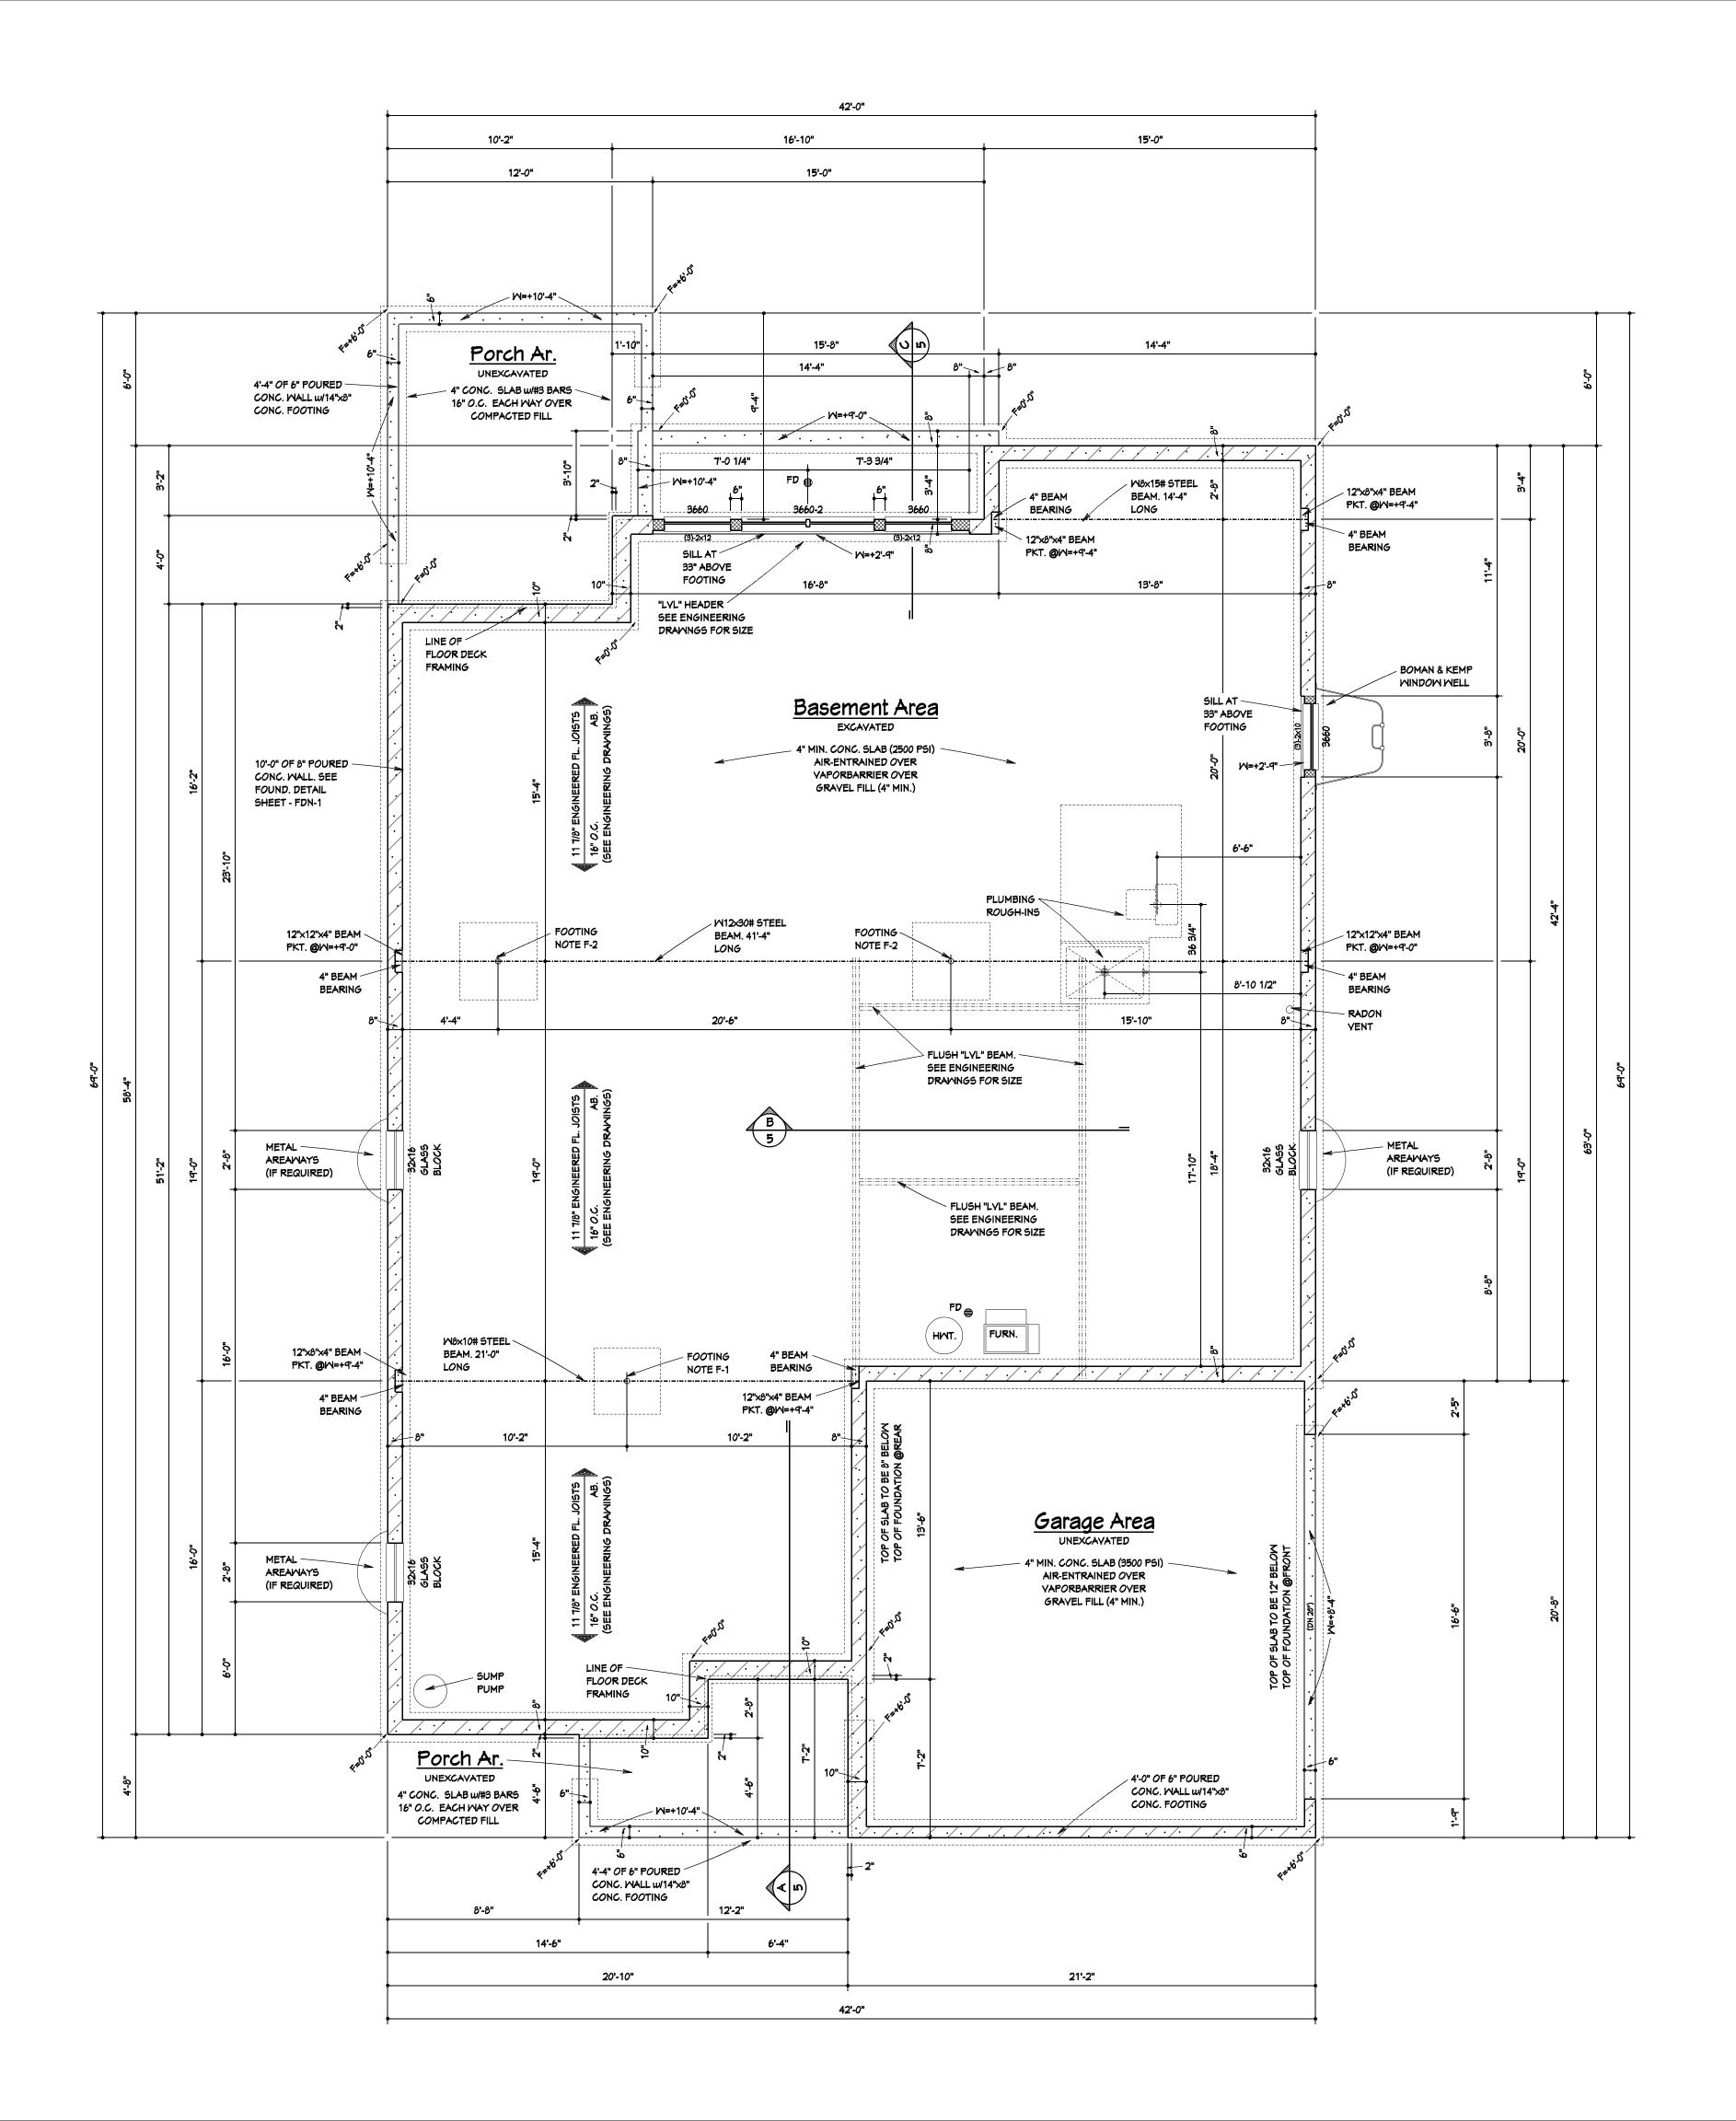
 Job No.
 Sheet No.

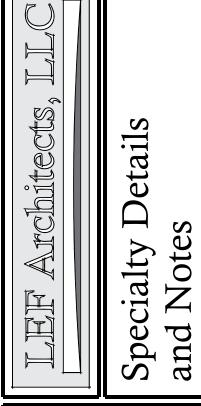 2017-129
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TBS-0037 03/08





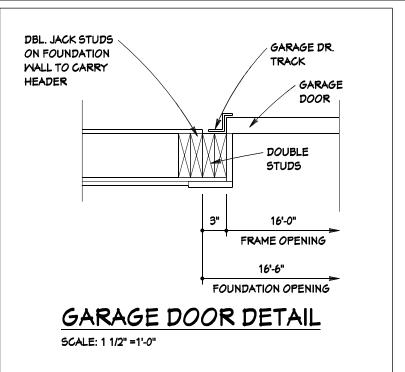

NOTE: SEE SHEET No. 1 FOR

"FOUNDATION NOTES"

NOTE:
BUILDER TO VERIFY THAT ALL

STRUCTURAL LOADS TRANSFER


FOOTING F-1

TO FOUNDATION.

36"X36"X18" CONC. FOOTING W/3" DIAMETER SCH. 40 ADJ. STEEL PIPE COLUMN (4)-#4 BARS EACH WAY

FOOTING F-2

42"X42"X18" CONC. FOOTING w/3" DIAMETER SCH. 40 ADJ. STEEL PIPE COLUMN (4)-#4 BARS EACH WAY No. DATE BY REVISIONS

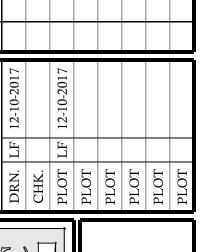



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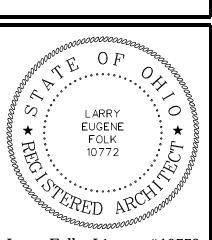
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 Sheet No.

 2017-129
 2A

"LVL" HEADER SEE ENGINEERING POURED CONC. MINDOM MELL DRAWNGS FOR SIZE w/LATTER Porch Area 4 1/2" 12'-11" STEEL BM 18 1/2" 14'-10" 14'-5 1/2" INSTALL 2x4 STUDS WITH AIR GAP BETWEEN CONCRETE WALL. <u>Bedrm. #3</u> 2x6 TOP PLATE AND 2x4 TREATED **BOTTOM PLATE** CARPET FLOOR <u>4 1/2"</u> 25'-2" - INSTALL 2x4 STUDS WITH AIR GAP - BOMAN & KEMP BETWEEN CONCRETE WALL. MINDOM MELL 5'-5 1/2" 2x6 TOP PLATE AND 2x4 TREATED **BOTTOM PLATE** Recreation Room 4 1/2" 4'-0" 4'-5 1/2" 8'-8 1/2" 6'-2" 3'-8" TILE FL. S/R STEEL P05T POST SHOWER 4'-4 1/2" 8'-8 1/2" 2'-1" 7'-7" 6'-8 1/2" **Utility Room** 20'-4" CONCRETE FLOOR FURN. STEEL / POST BEAM Utility Room concrete floor Garage Area SUMP PUMP Porch Area

7'-0 1/4"

7'-3 3/4"


1. - ALL DOORS TO BE 6'-8" TALL UNLESS NOTED

EXCEPT FOR STEEL BEAMS AND/OR
HEADERS THE STRUCTURAL ELEMENTS
SHOWN ON THESE DRAWINGS IS FOR
DESIGN INTENT ONLY.

REFER TO MANUFACTURER SUPPLIED STRUCTURAL SHEETS FOR ALL JOISTS, BEAMS, HEADERS, TRUSSES AND RAFTERS FOR SIZES AND LOCATIONS.

SEE SHEET No. 1 FOR "GENERAL NOTES"

BUILDER TO VERIFY THAT ALL STRUCTURAL LOADS TRANSFER TO FOUNDATION.

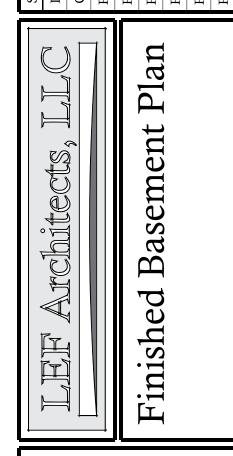


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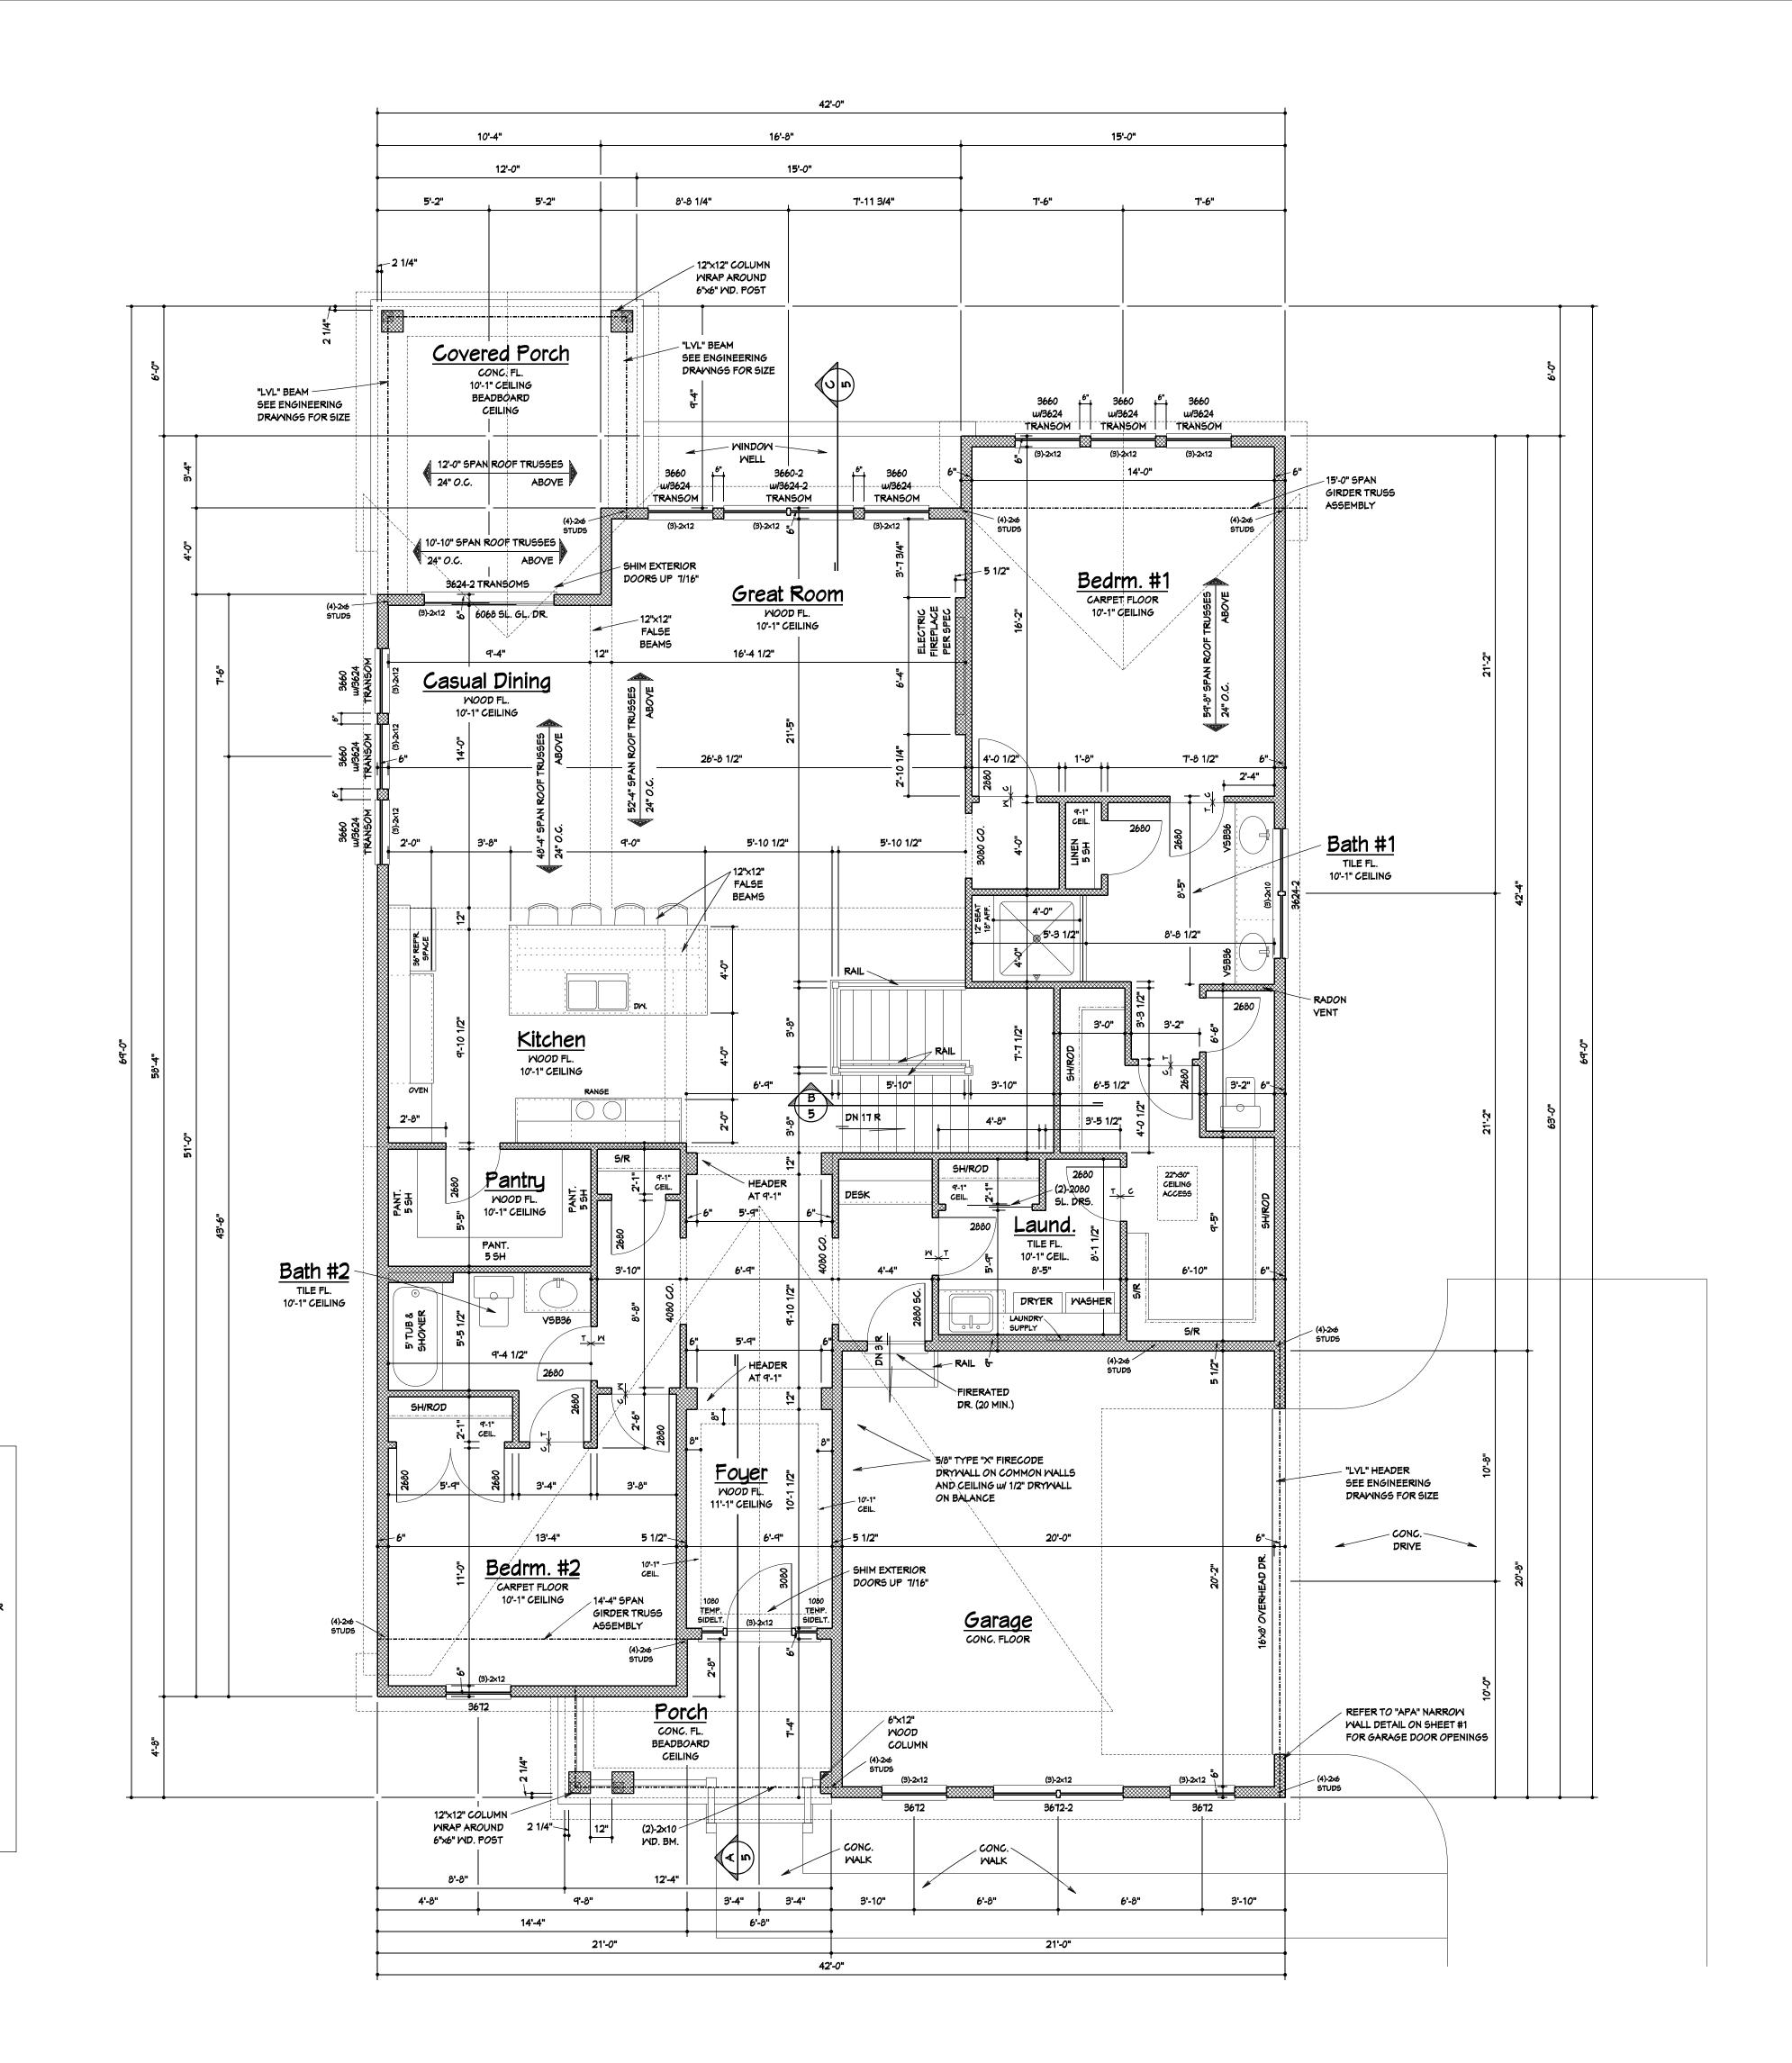
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Spec. Residence 7221 Craigens Court Lot #4 Britonwood

Job No. Sheet No. 2017-129



NOTE:
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DESIGN INTENT ONLY.
REFER TO MANUFACTURER SUPPLIED

STRUCTURAL SHEETS FOR ALL JOISTS, BEAMS, HEADERS, TRUSSES AND RAFTERS FOR SIZES AND LOCATIONS.

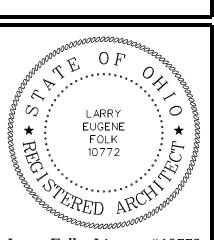NOTE: THE EXTERIO

THE EXTERIOR WALLS OF THIS STRUCTURE ARE CONTINUOUSLY SHEATHED WITH 1/2" OSB TO COMP WITH THE BRACE REQUIREMENTS USING METHOD CS-WSP. ANY WALL AREAS THAT REQUIRE ALTERNATE BRACING METHODS AND LABELED WITH SPECIFIC METHOD REQUIRED. (SEE GARAGE NARROW WALL DETAIL ON SHEET #1)

THIS SHEATHING SHALL EXTEND AND BE ATTACHED TO THE SILL AND CAP PLATES OF THE WALLS. THE MUD SILL PLATES SHALL BE ANCHORED TO THE FOUNDATION WITH A MIN. OF 1/2" DIA. BOLTS SPACED NO MORE THAN 6'-0" O.C. OR 1/2" DIA EXPANSION BOLTS AT 48" O.C. THESE ANCHOR BOLTS SHALL BE LOCATED BETWEEN 8" AND 12" FROM THE CORNERS AND ON EITHER SIDE OF DOORS THAT HAVE A THRESHOLD BELOW THE SILL PLATE.

PER METHOD CS-MSP ALL HORIZONTAL JOINTS IN THE SHEATHING WILL BE BLOCKED TO ACCOMMODATE THE CODE SPECIFIED FASTENING REQUIREMENTS OF:


6" O.C. AT EDGES AND 12" O.C. IN THE INTERIOR OF THE PANELS USING 8d COMMON NAILS


OR ALTERNATE METHOD OF 3" O.C. AT EDGES AND 6" O.C. IN THE INTERIOR OF THE PANELS USING 16GA. 3/8" CROWN STAPLES, 1 5/8" LONG.

ANY TRUSS HEELS OVER 9 1/4" WILL HAVE OSB EXTENDED TO WITHIN 2" OF THE UNDERSIDE OF THE RAFTER TAIL AND FASTENED IN THE SAME MANNER. TRUSS HEEL SHEATHING MUST SPAN ACROSS THE TOP PLATE/TRUSS CONNECTION OR EXTEND DOWN THE WALL AT LEAST 24" AND THE SAME HORIZONTAL BLOCKING MUST BE PROVIDED BETWEEN THE TRUSS FOR NAILING AS SPECIFIED ABOVE.

NOTE: SEE SHEET No. 1 FOR "GENERAL NOTES"

NOTE: BUILDER TO VERIFY THAT ALL STRUCTURAL LOADS TRANSFER TO FOUNDATION.

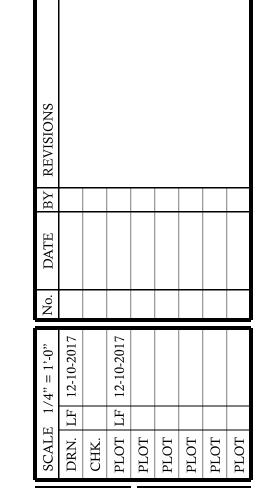

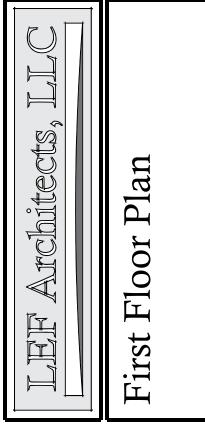

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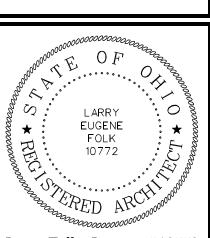
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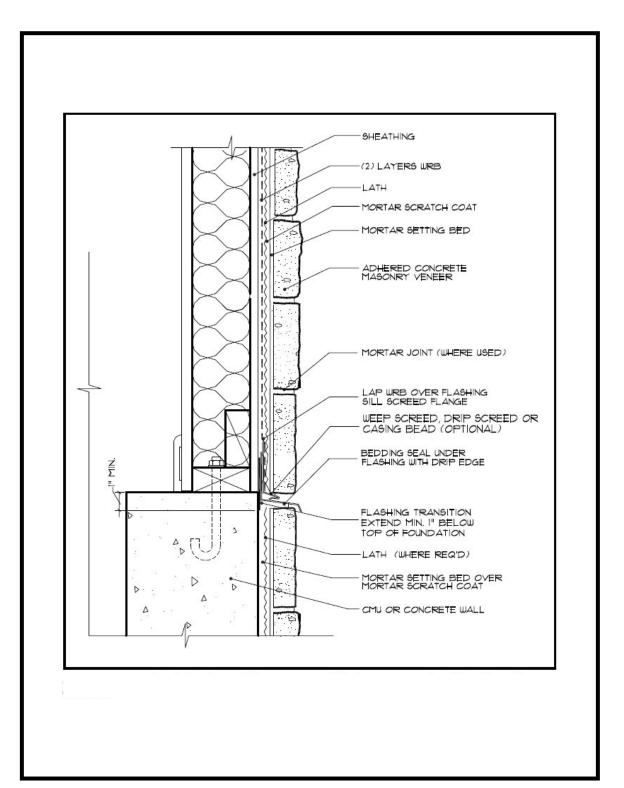
PRELIMINARY
BIDDING
CONSTRUCTION




Spec. Residence 7221 Craigens Court Lot #4 Britonwood

 Job No.
 Sheet No.

 2017-129
 3




703.6.2.1 Weep Screeds. A mininum 0.019 (0.5mm) (No. 26 galvanized sheet gauge), corrosion-resistant weep screed or plastic weep screed, with a minimum vertical attachement flange of 3-½ inches (89 mm) shall be provided at or below the foundation plate line on exterior stud walls in accordance with ASTM C 926. The weep screed shall be placed a minimum of 4 inches (102 mm) above the earth or 2 inches (51 mm) above paved areas and shall be a type that will allow trapped water to drain to the exterior of the building. The weather-resistant barrier shall lap the attachment flange. The exterior lath shall cover and terminate on the attachement flange of the weep screed.

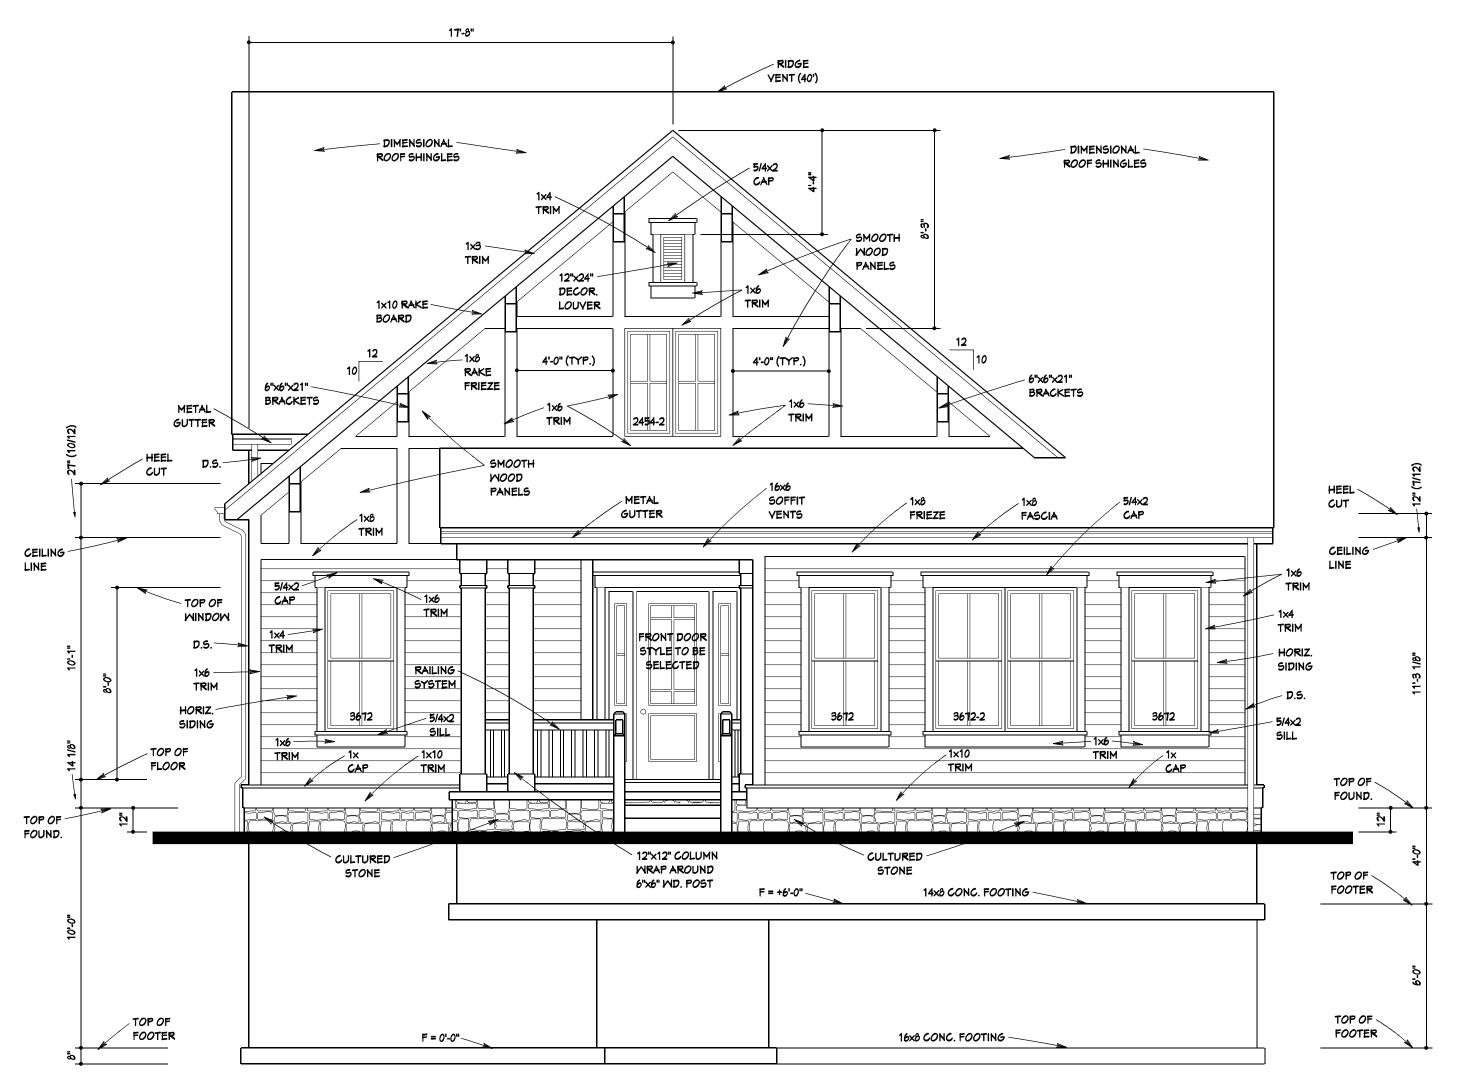

FRONT ELEVATION

SCALE: 1/4" =1'-0"

1'-0" No. DATE BY REVISIONS
1-2017
1-2017

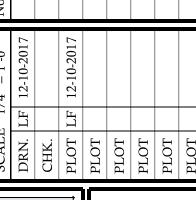



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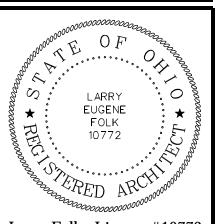
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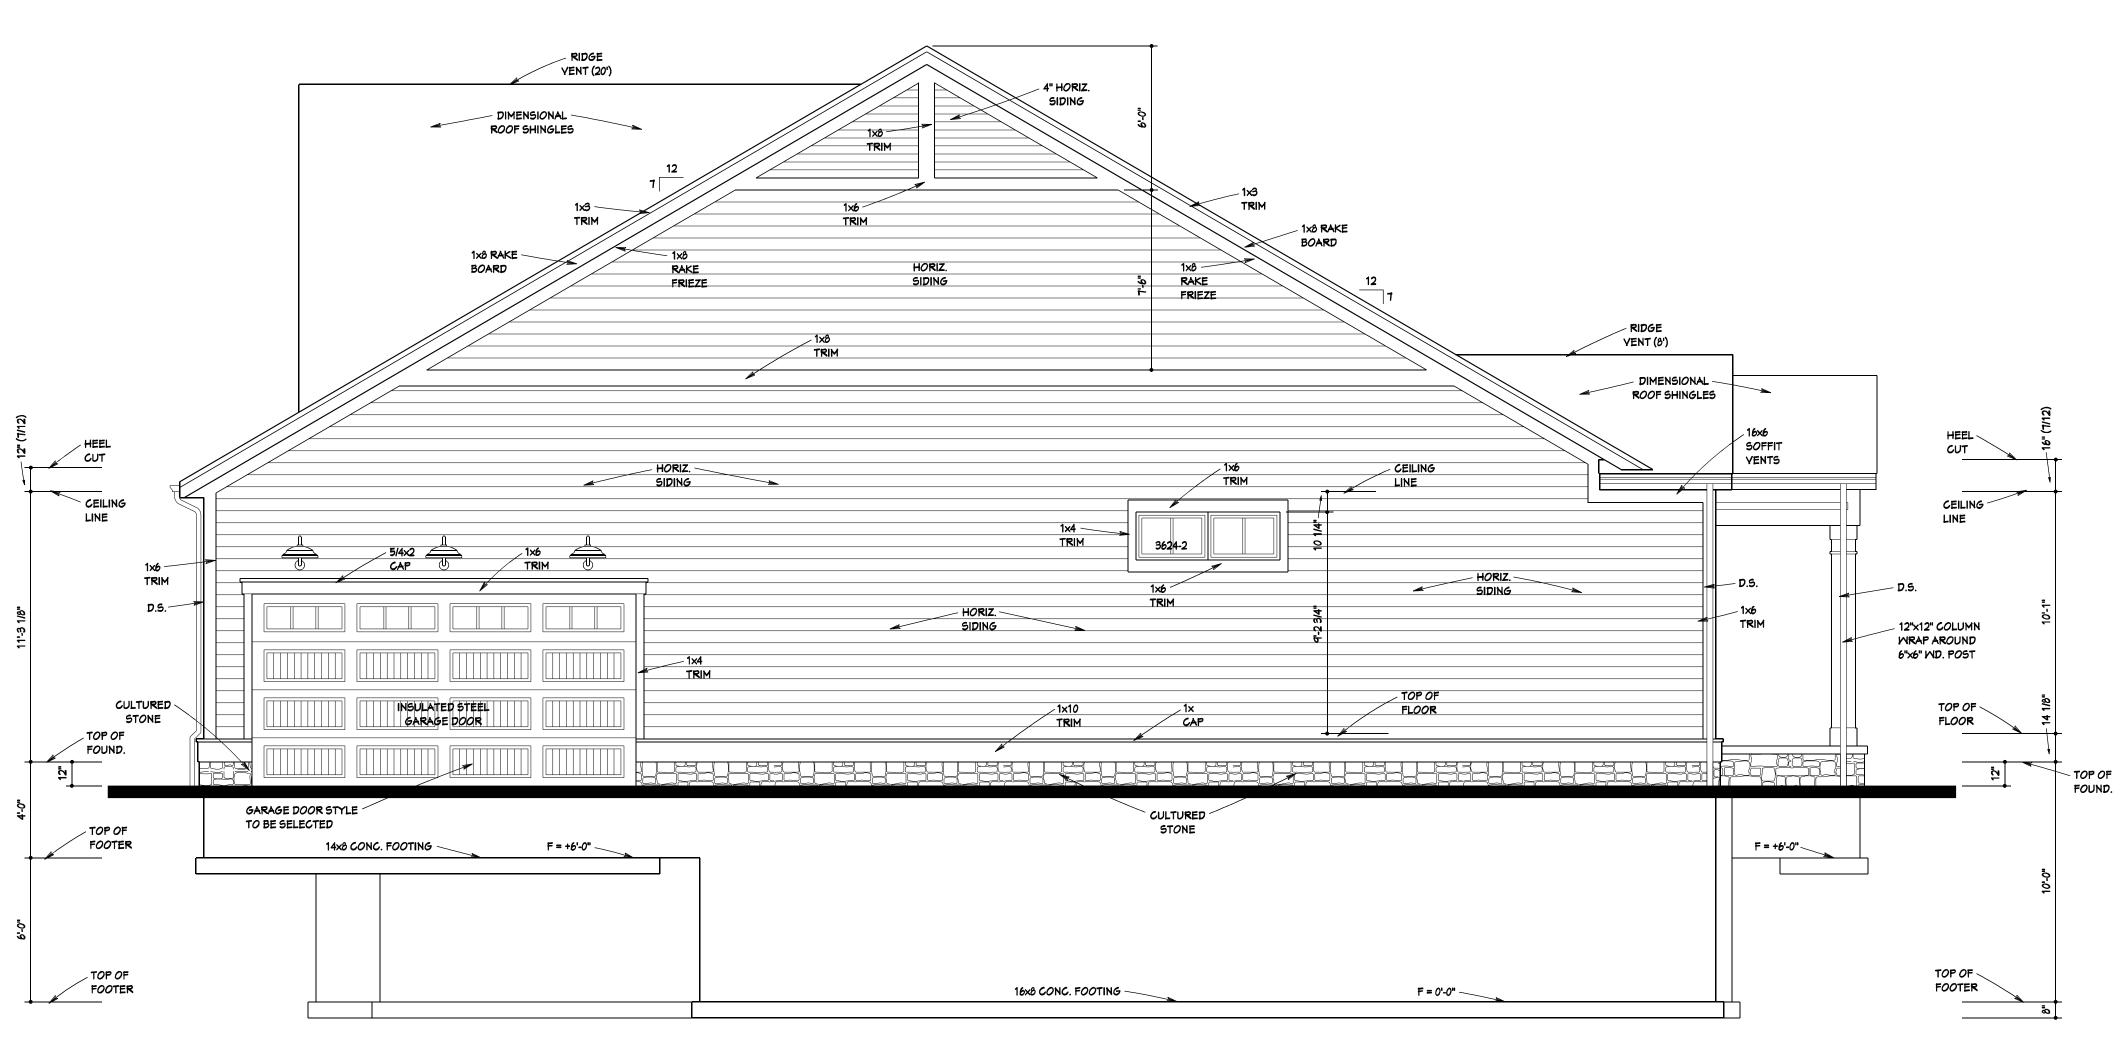
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Spec. Residence 7221 Craigens Court Lot #4 Britonwood


 Job No.
 Sheet No.

 2017-129
 4-A



RIGHT SIDE ELEVATION

SCALE: 1/4" =1'-0"

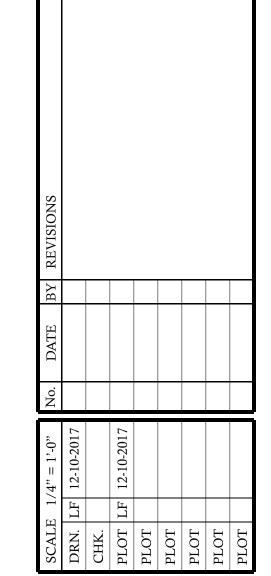



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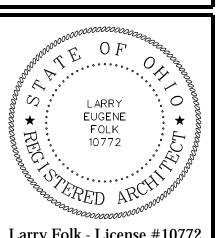
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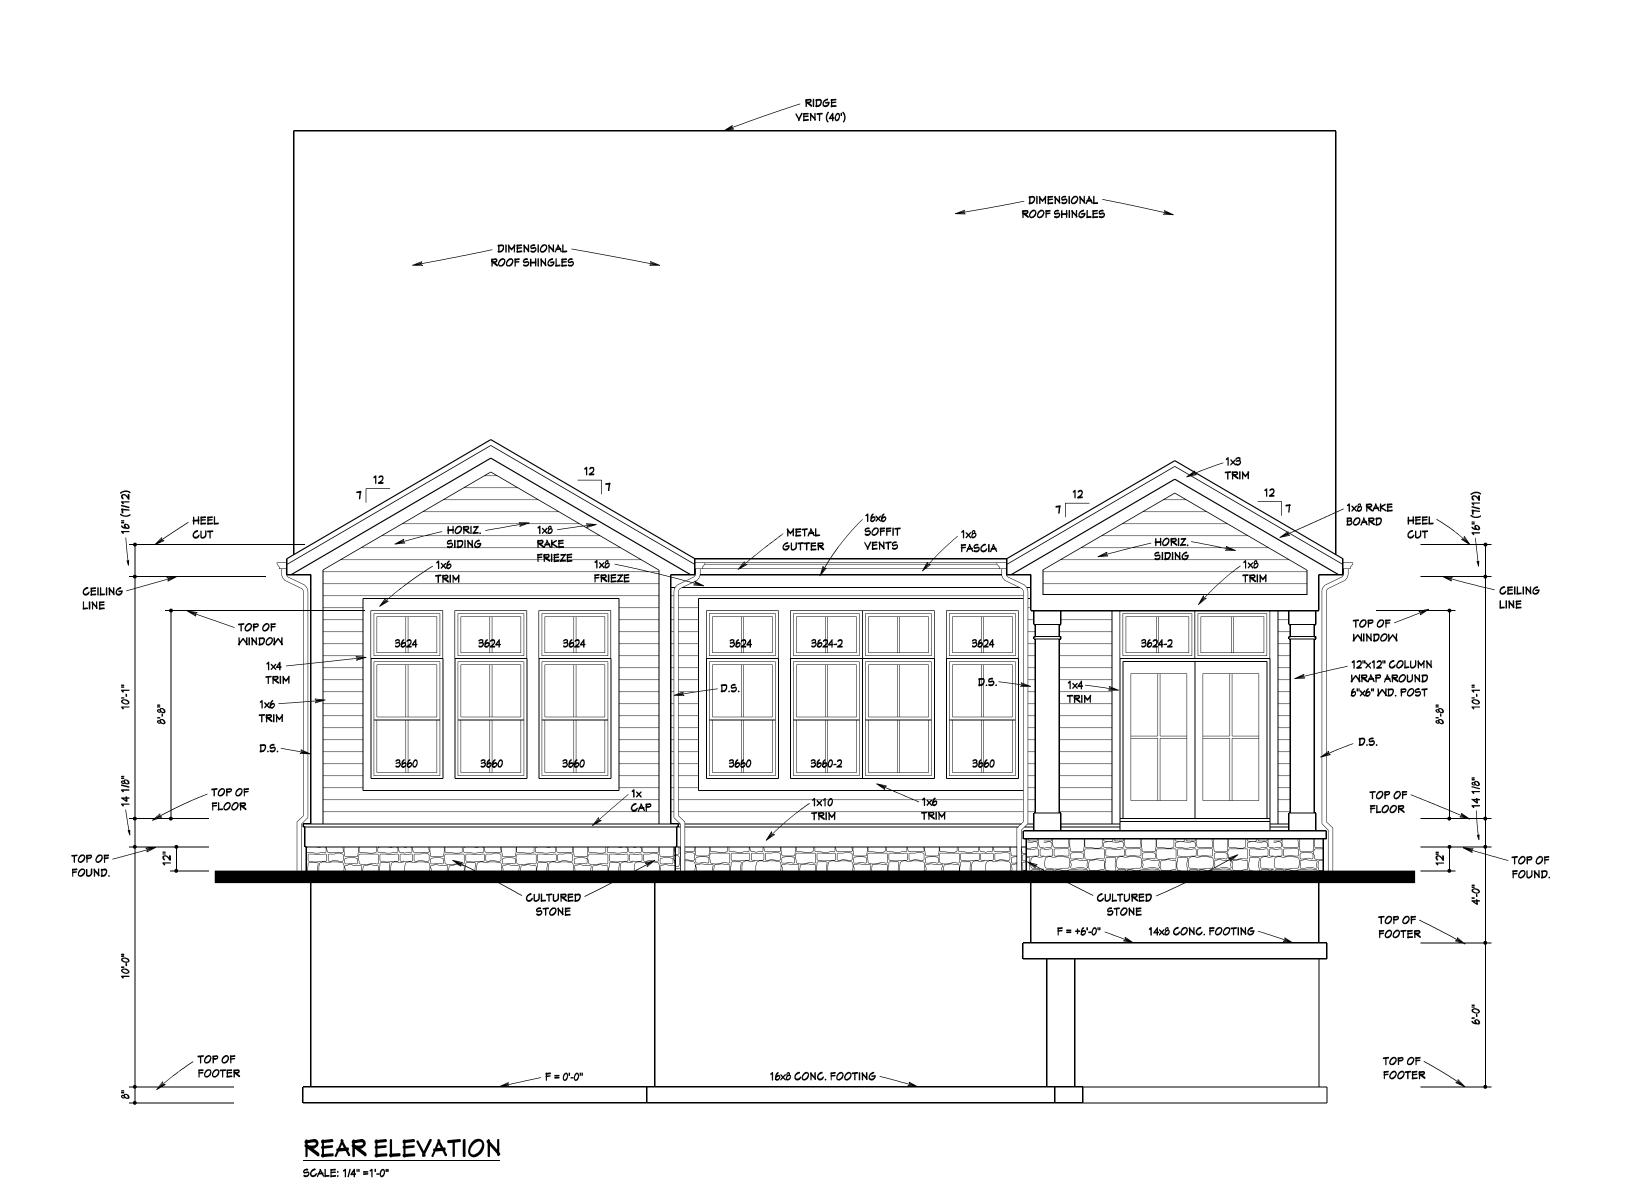
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Spec. Residence 7221 Craigens Court Lot #4 Britonwood

 Job No.
 Sheet No.

 2017-129
 4-B




SCALE 1/4" = 1'-0"

DRN. LF 12-10-2017

CHK.

PLOT

PL

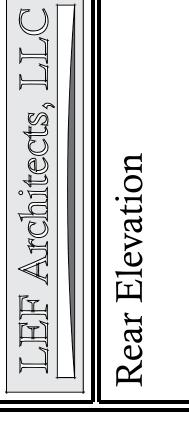

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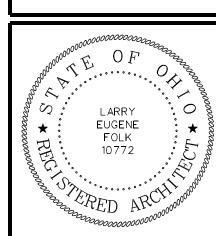
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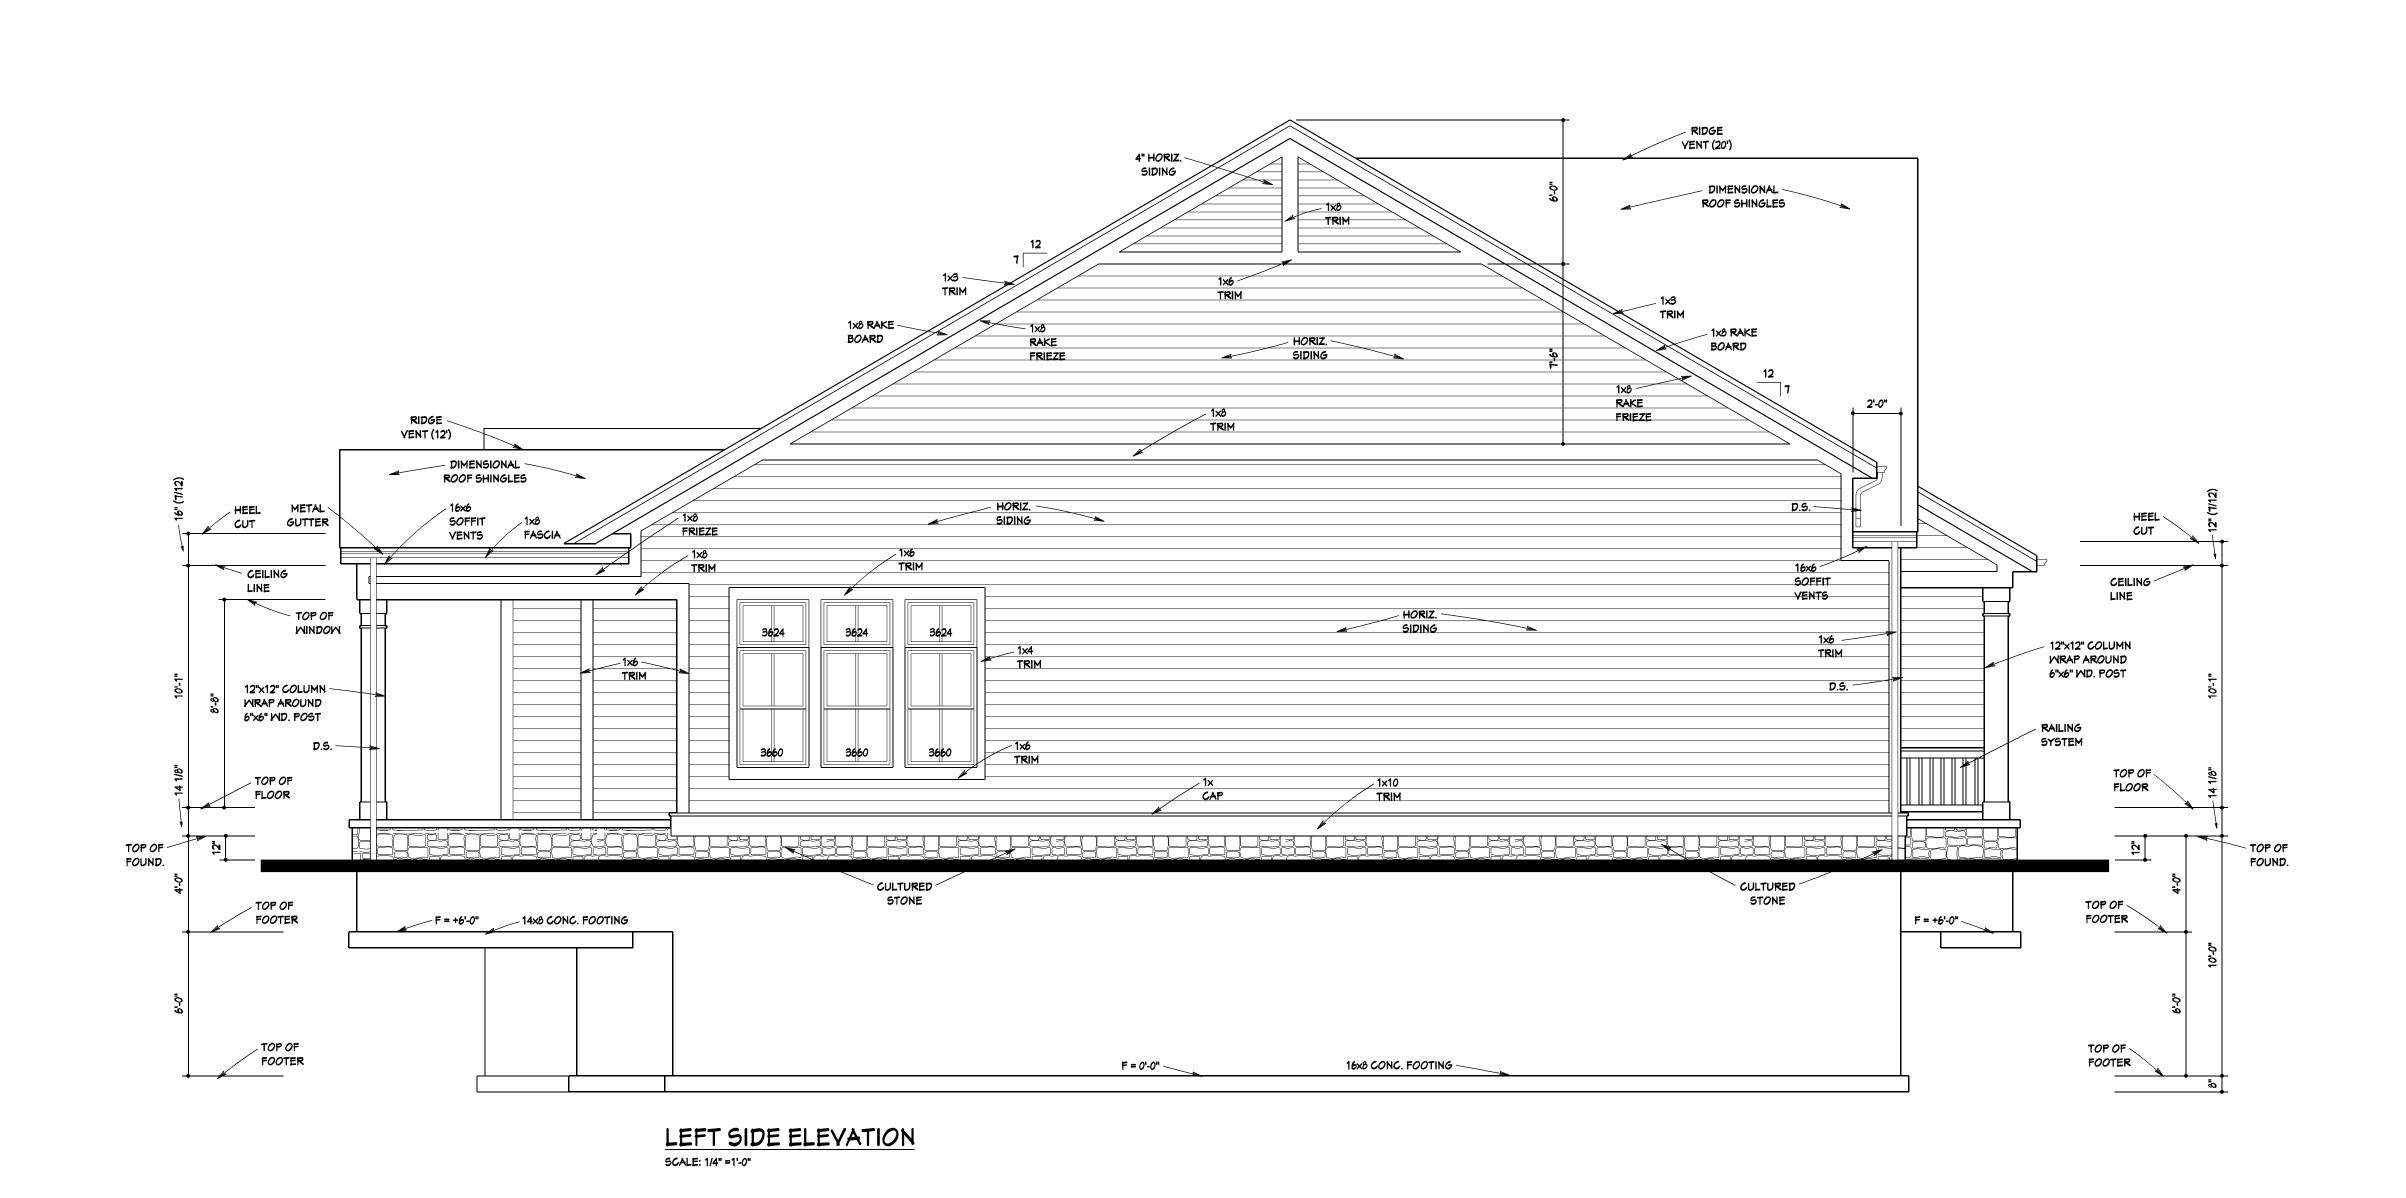
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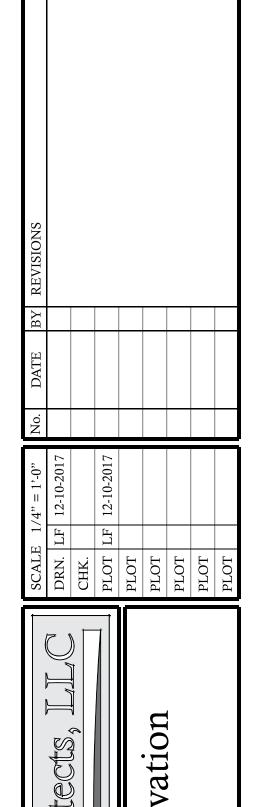


Spec. Residence 7221 Craigens Court Lot #4 Britonwood

 Job No.
 Sheet No.

 2017-129
 4-C





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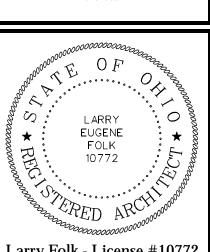
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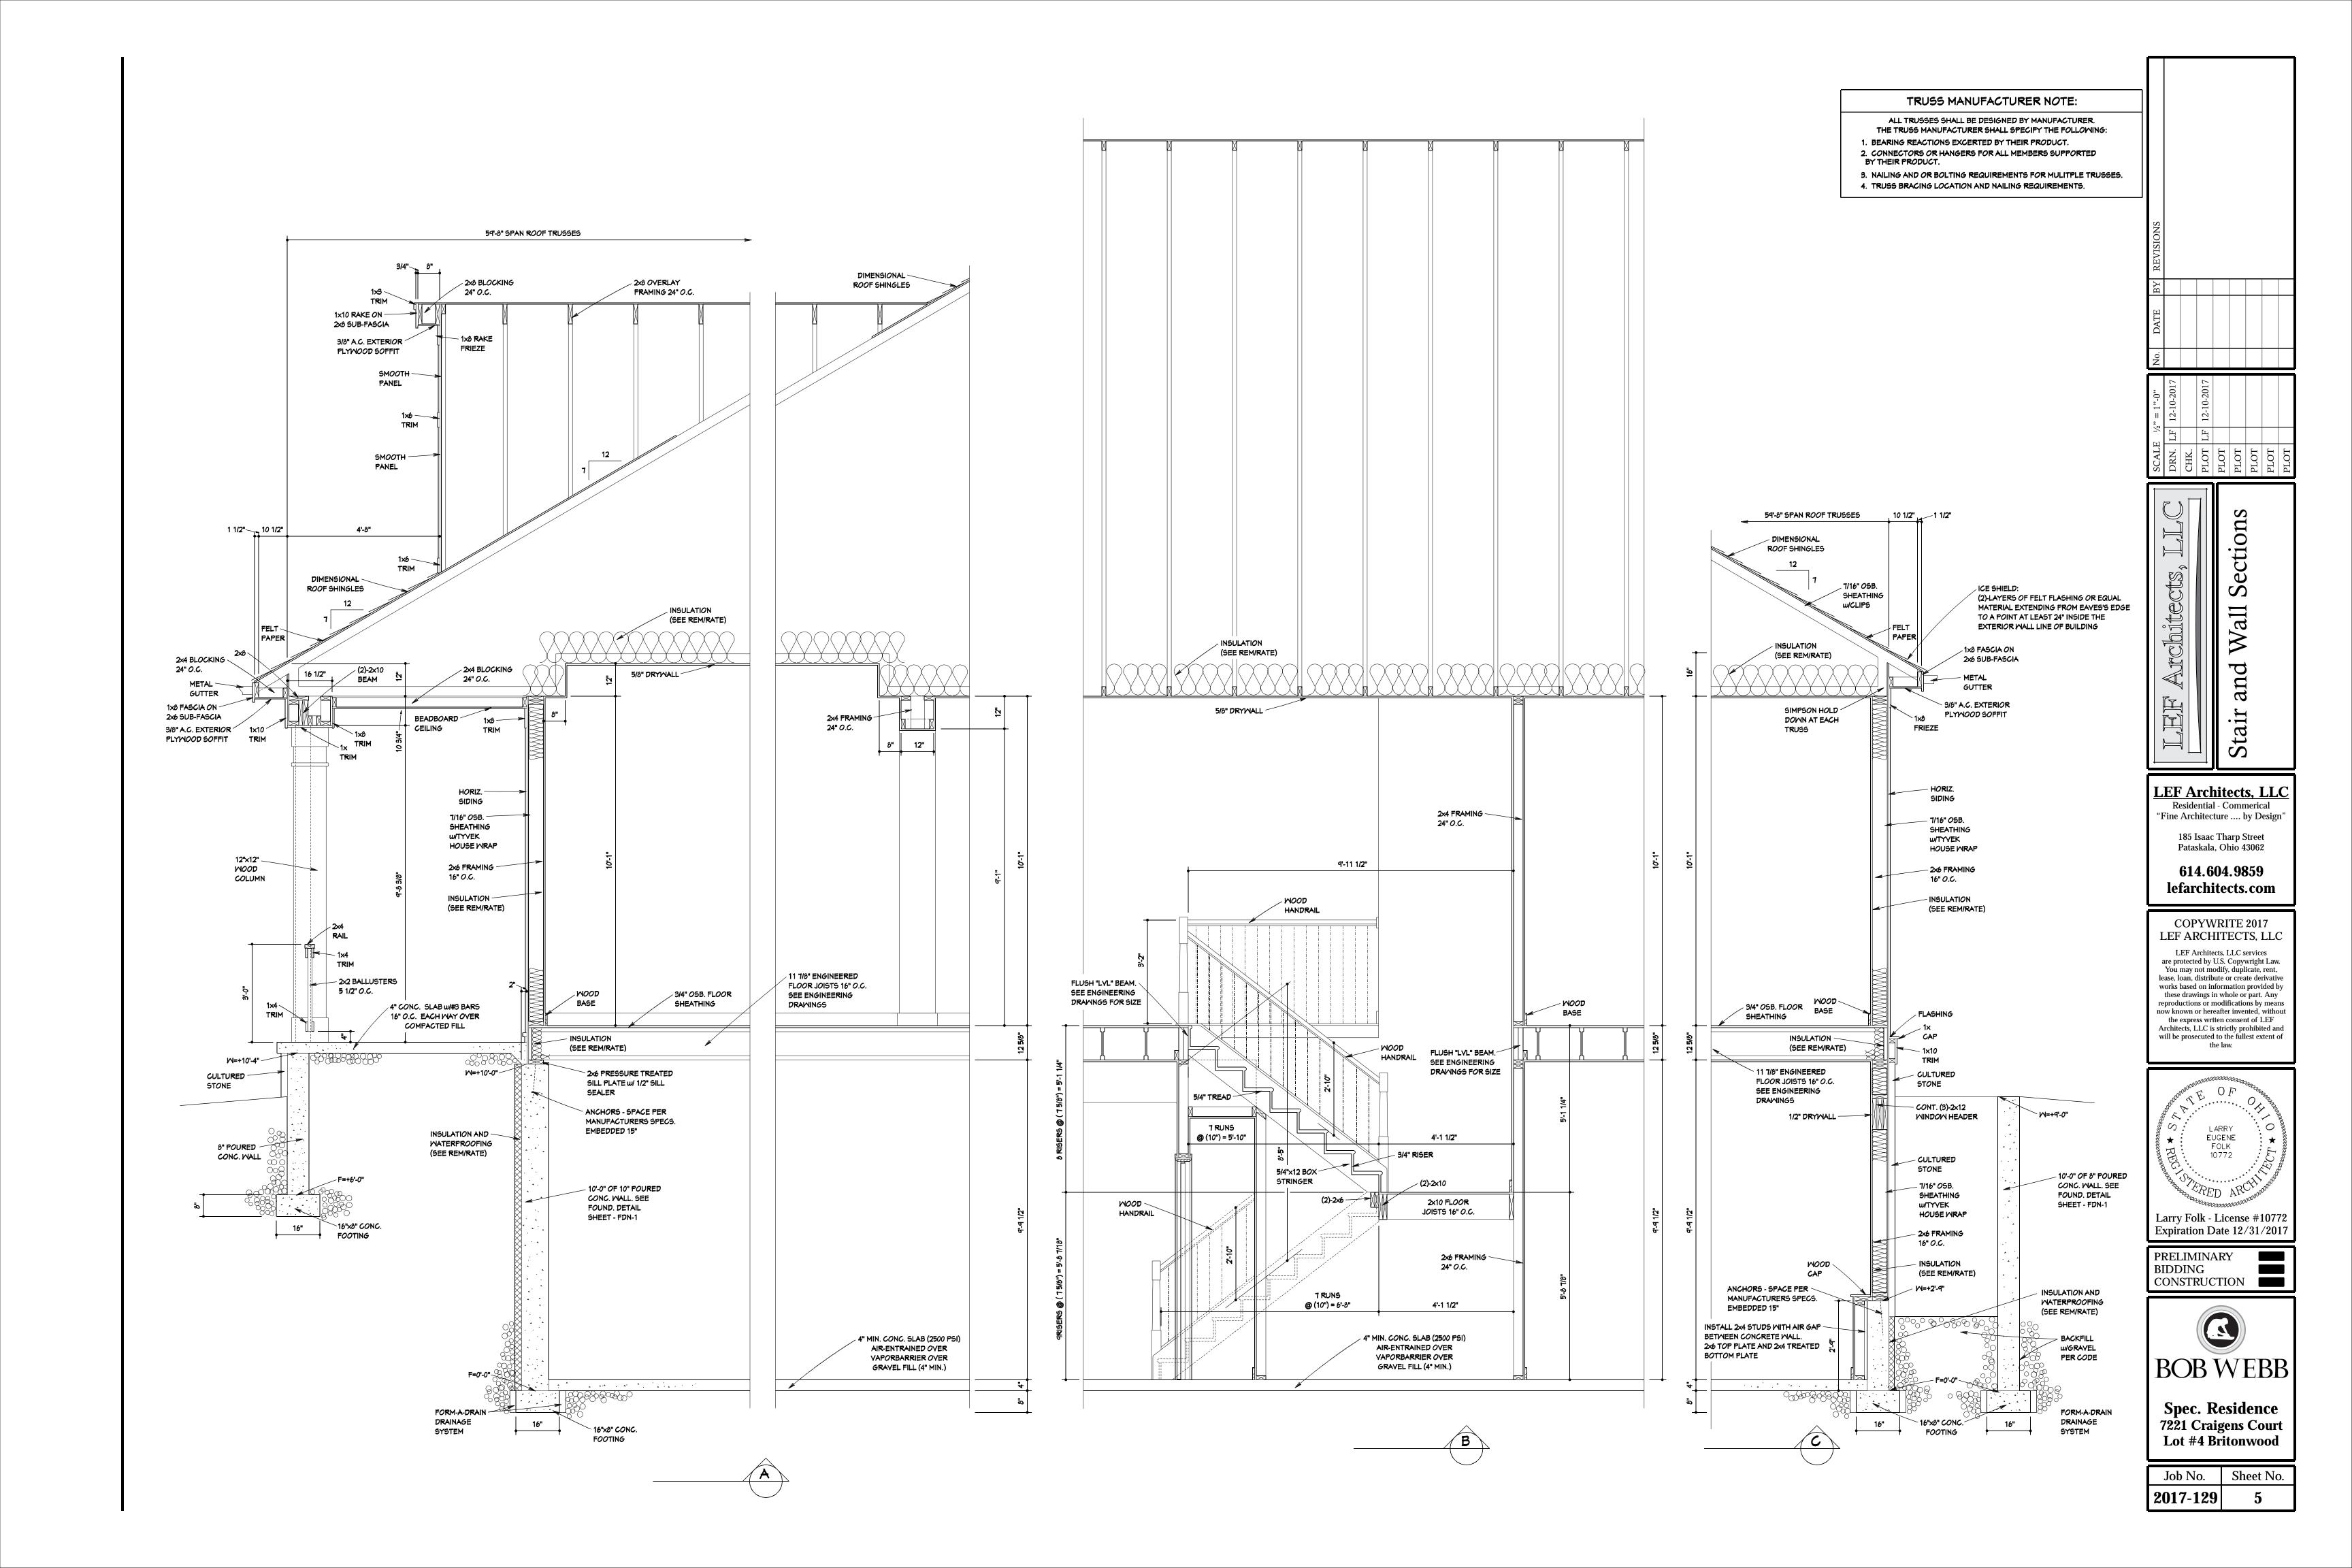
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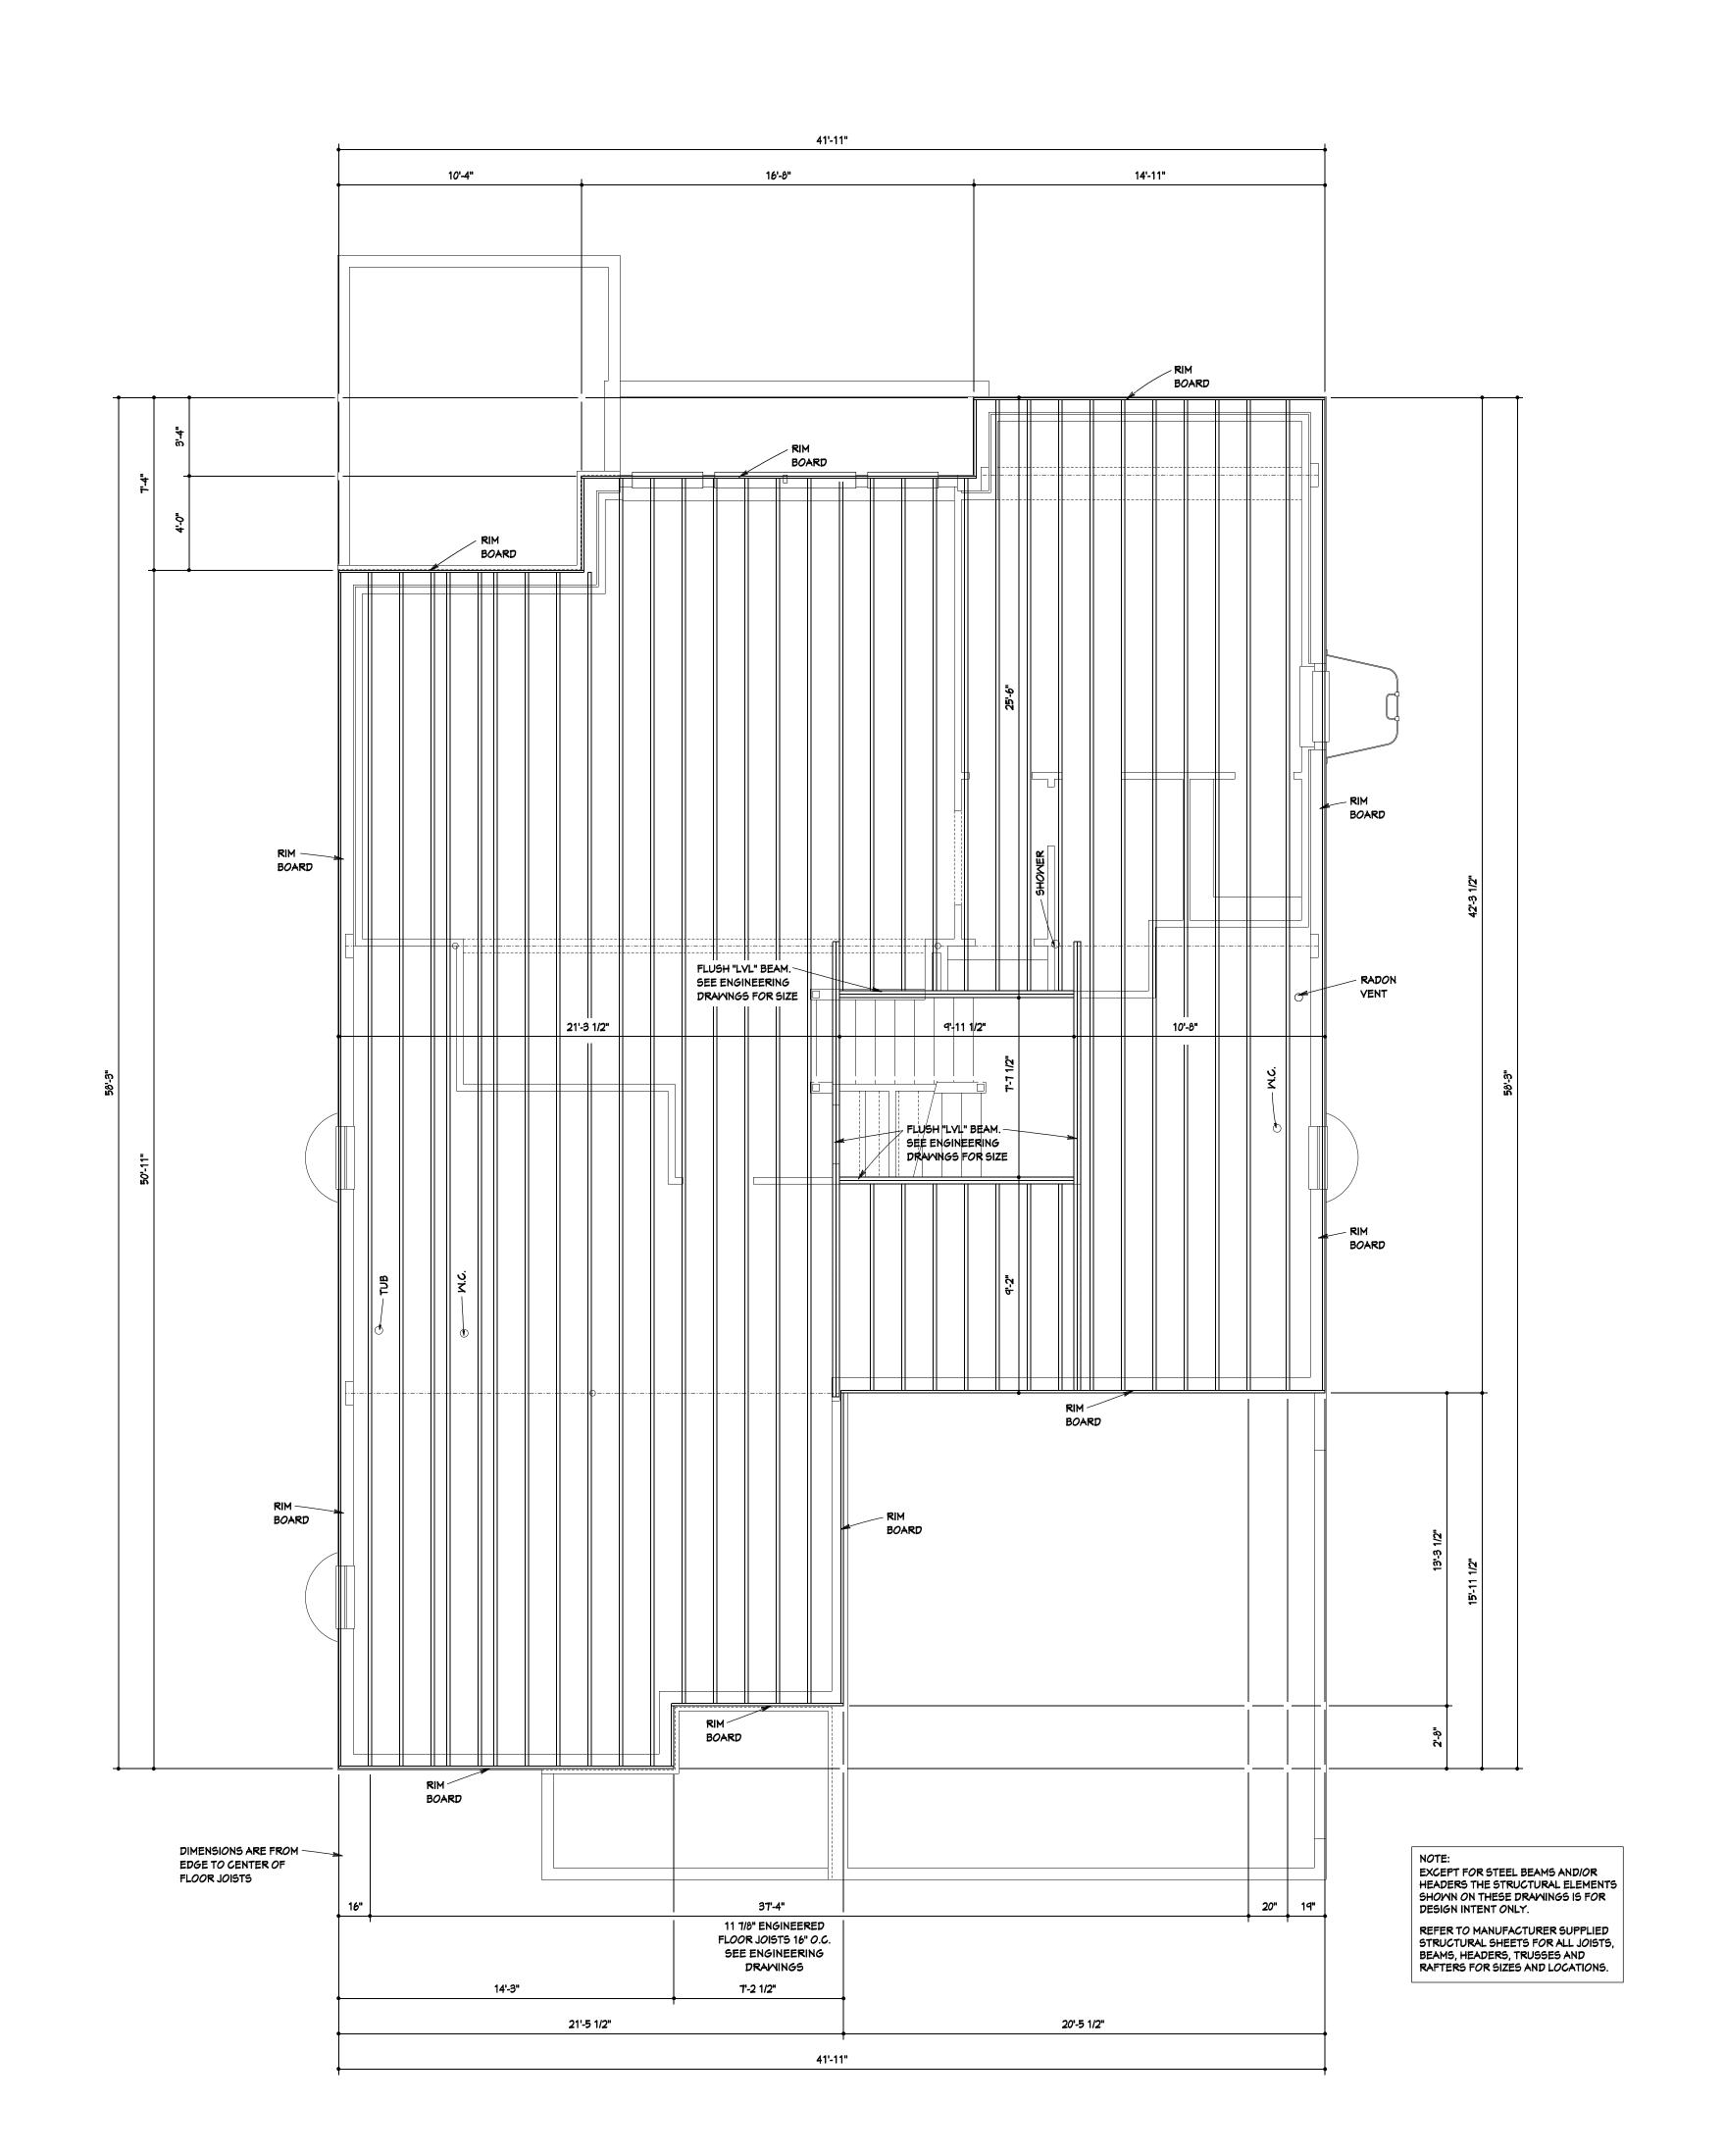
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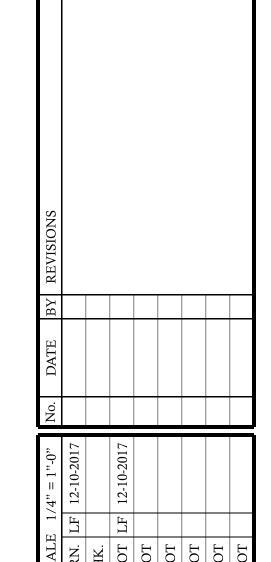


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Job No. Sheet No. **2017-129 4-D**









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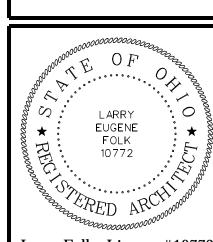
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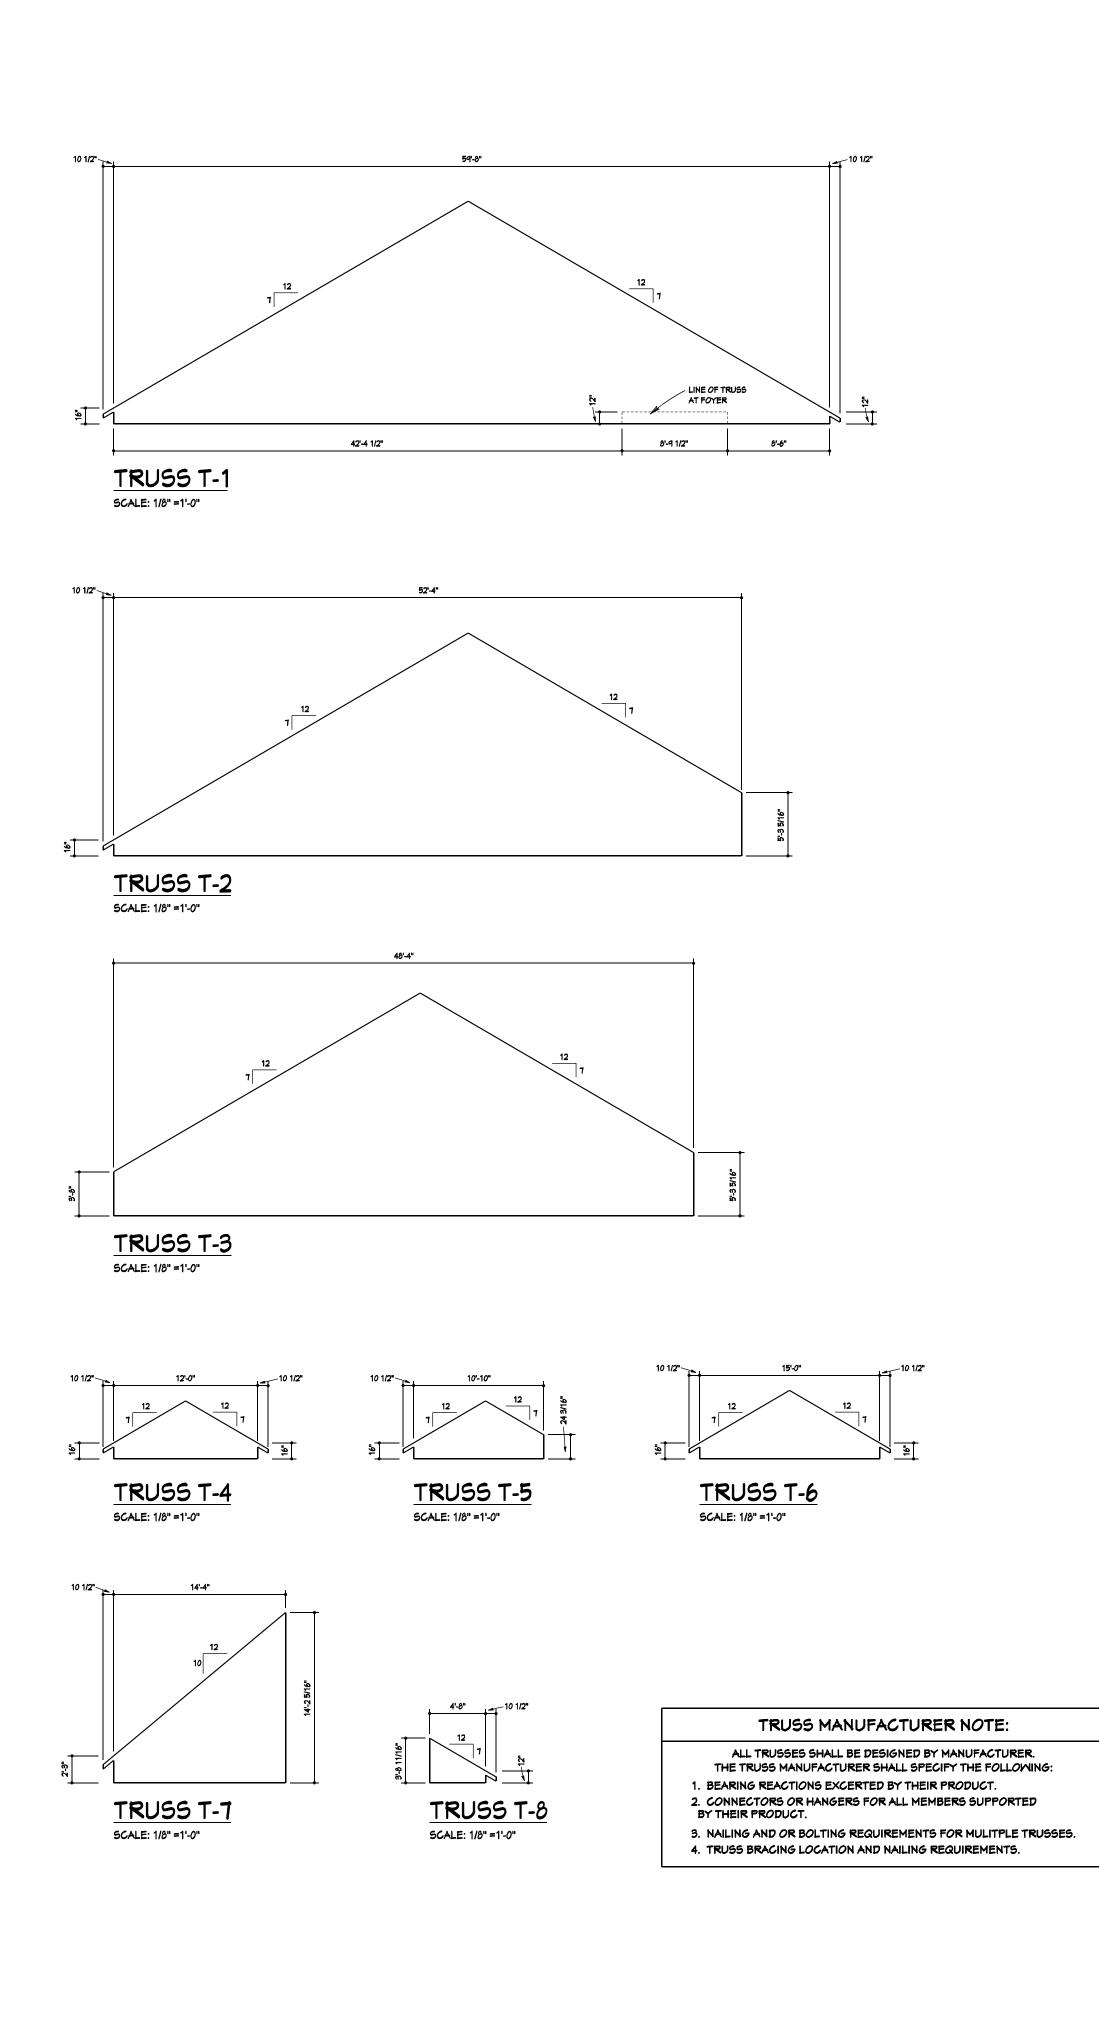
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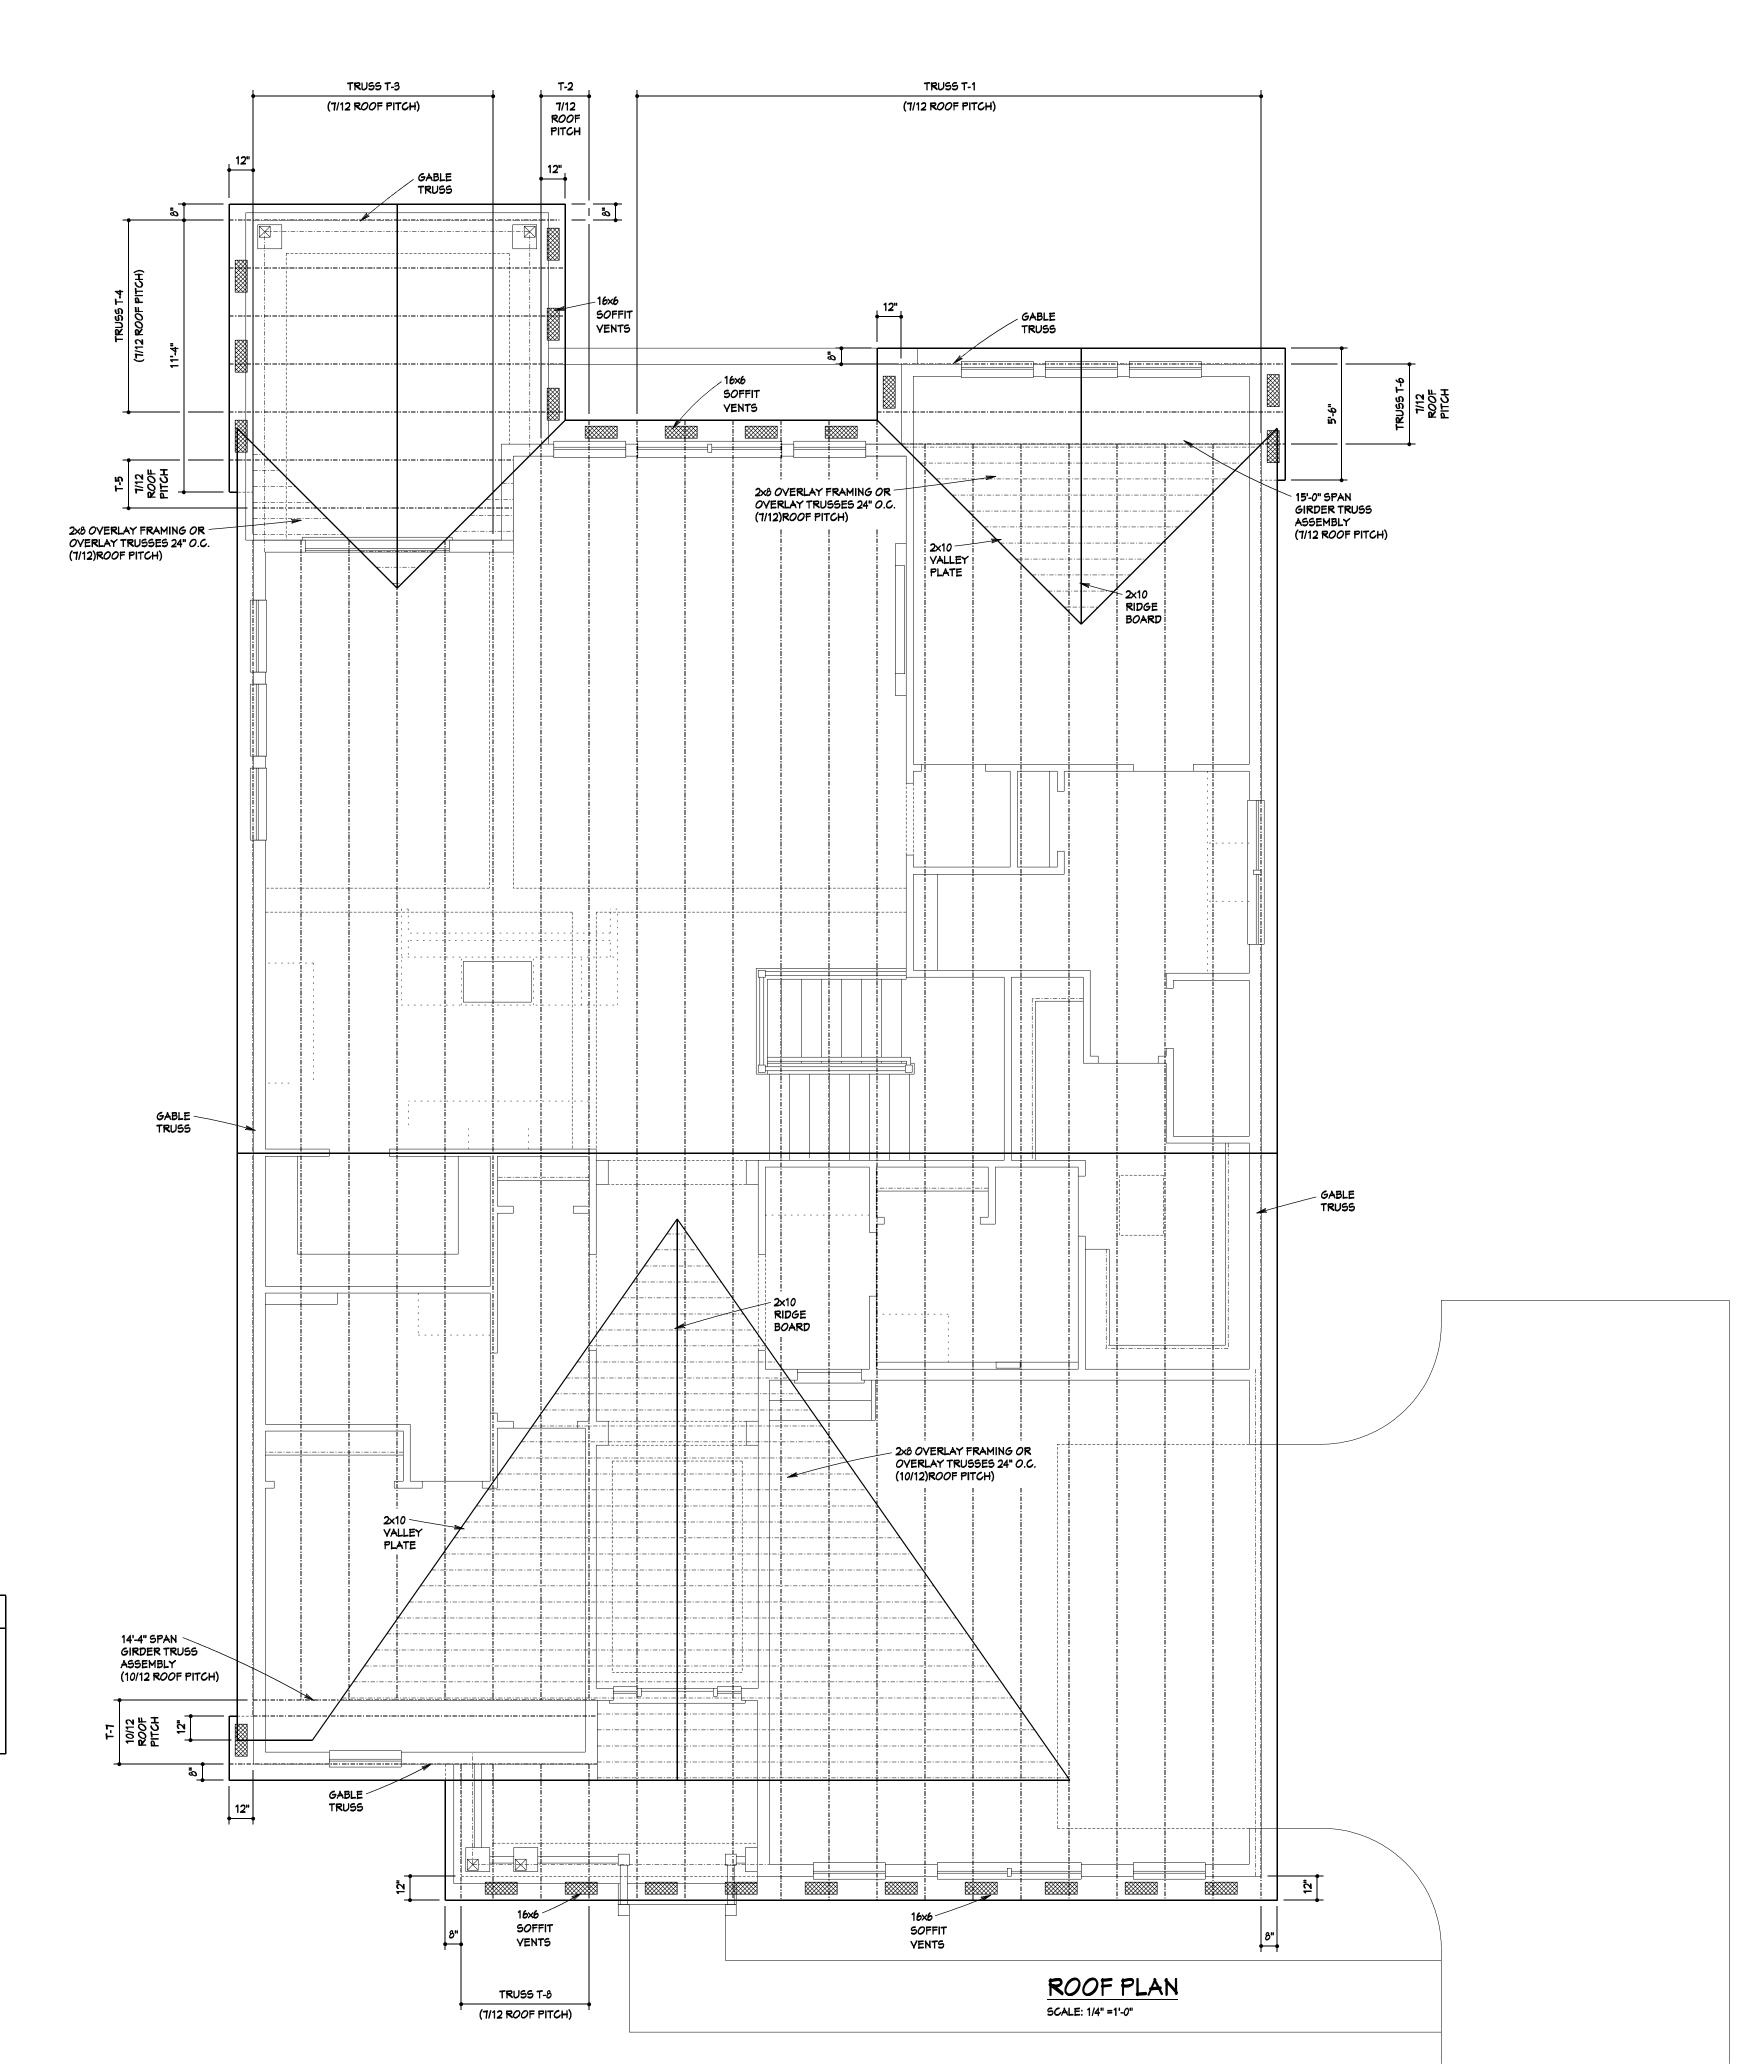
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CONSTRUCTION




Spec. Residence 7221 Craigens Court Lot #4 Britonwood

Job No. Sheet No. **2017-129 F-2**





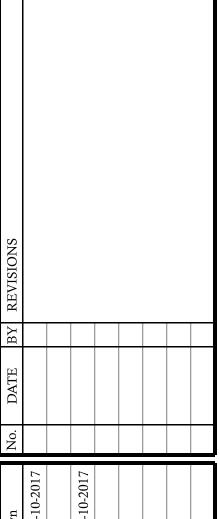




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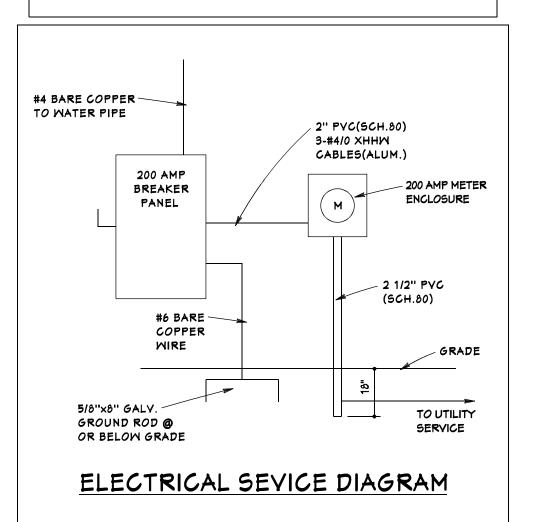
Job No. Sheet No. F-3 2017-129


GROUNDING ELECTRODE SYSTEM INSTALLATION

- A) ROD, PIPE, AND PLATE ELECTRODES SHALL MEET THE REQUIREMENTS OF N.E.C 250.53 (A)(3)
- IF PRACTICABLE, ROD, PIPE & PLATE RELATED ELECTRODES SHALL BE EMBEDDED BELOW PERMANENT MOISTURE LEVEL. ROD, PIPE & PLATE ELECTRODES SHALL BE FREE FROM NON-CONDUCTIVE COATINGS SUCH AS PAINT OR ENAMEL.
- A SINGLE ROD, PIPE OR PLATE ELECTRODE SHALL BE SUPPLEMENTED BY AN ADDITIONAL ELECTRODE OF A TYPE SPECIFIED IN 250.52(A)(2) THROUGH (A)(8). THE SUPPLEMENTAL ELECTRODE SHALL BE PERMITTED TO BE BINDED TO ONE OF THE FOLLOWING;

1) ROD, PIPE OR PLATE ELECTRODE 2) GROUNDING ELECTRODE CONDUCTOR 3) GROUNDED SERVICE ENTERANCE CONDUCTOR 4) NONFLEXIBLE GROUNDED SERVICE RACEWAY 5) ANY GROUNDED SERVICE ENGLOSURE

- IF MULTIPLE ROD, PIPE OR PLATE ELECTRODES ARE INSTALLED TO MEET THE REQUIREMENTS OF THIS SECTION, THEY SHALL NOT BE LESS THAN 6' APART.
- WHERE MORE THAN ONE OF THE ELECTRODES OF THE TYPE SPECIFIED IN 25.52(A)(5) OR (A)(1) ARE USED, EACH ELECTRODE OF ONE OF GROUNDING SYSTEM(INCLUDING THAT USED FOR STRIKE TERMINATION DEVICES) SHALL NOT BE LESS THAN 6' FROM ANY OTHER ELECTRODE OF ANY OTHER GROUNDING SYSTEM. TWO OR MORE GROUNDING ELECTRODES THAT ARE BONDED TOGETHER SHALL BE CONSIDERED A SINGLE ELECTRODE GROUNDING SYSTEM.
- C) THE BONDING JUMPER(S) USED TO CONNECT THE GROUNDING ELECTRODES TOGETHER TO FROM THE GROUNDING ELECTRODE SYSTEM SHALL BE INSTALLED IN ACCORDANCE WITH 250.66 AND SHALL BE CONNECTED IN THE MANNER SPECIFIED IN 250.70.

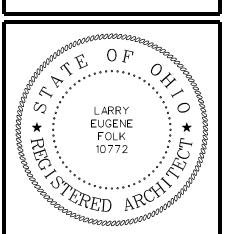

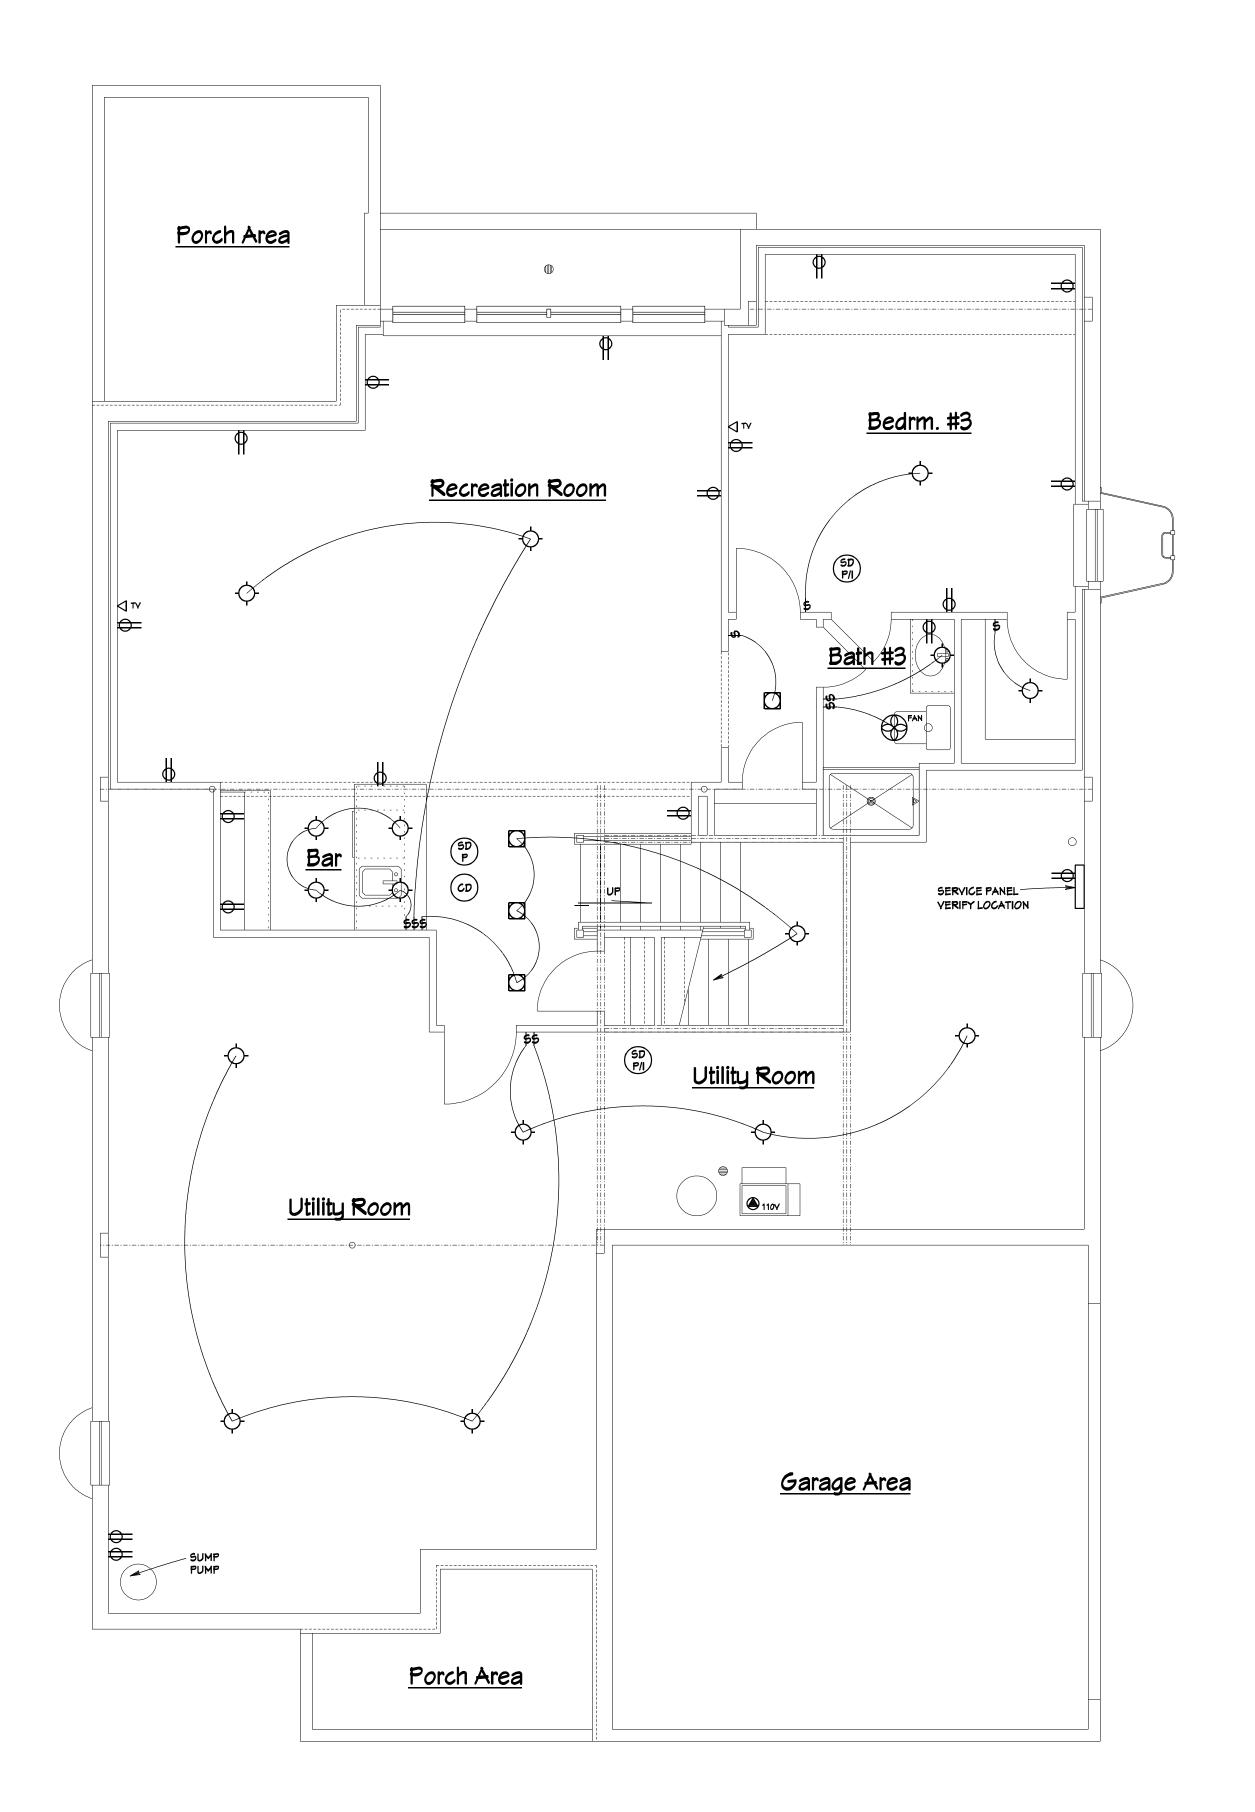

ELECTRICAL NOTES

- 1) ALL ELECTRICAL WIRING TO BE INSTALLED PER N.E.C. 2014
- 2) ELECTRICAL SERVICE LOAD SHALL BE
- CALCULATED PER N.E.C. ARTICLE 220 3) GENERAL USE OUTLETS SHALL BE INSTALLED
- PER N.E.C. 210.52 4) THERE SHALL BE AT LEAST (2)-20 AMP SMALL
- APPLIANCE CIRCUITS TO FEED ALL WALL AND FLOOR OUTLETS IN THE KITCHEN, PANTRY, BREAKFAST ROOM, DINING ROOM OR SMALLER AREAS.
- 5) OUTLETS INSTALLED ALONG KITCHEN SPACES, ISLANDS & PENINSULAS SHALL BE SPACED PER N.E.C 210.52 C(1), (2) AND (3)
- 6) THERE SHALL BE AT LEAST (1)-20 AMP CIRCUIT TO SUPPLY BATHROOM RECEPTACLE OUTLETS PER N.E.C. 210.10 C(3)
- 7) THERE SHALL BE AT LEAST (1)-20 AMP CIRCUIT TO SUPPLY THE LAUNDRY ROOM PER N.E.C. 210.10 C(2) AND 210.52 F
- 8) ALL RECEPTACLE OUTLETS IN UNFINISHED BASEMENTS, GARAGES AND ON THE EXTERIOR OF THE HOUSE SHALL BE GFCI PROTECTED PER N.E.C. 210.8
- 4) ALL 120 VOLT 15 AND 20 AMP BRANCH CIRCUITS SUPPLYING OUTLETS INSTALLED IN: FAMILY RM, DINING RM, LIVING RM, PARLOR, LIBRARY, DEN, BEDROOMS, SUN ROOM, REC ROOM, CLOSET, HALLWAY OR SMALLER ROOMS SHALL BE ARC FAULT PROTECTED PER N.E.C. 210.12 B
- 10) ALL CEILING AND WALL MOUNT LIGHT BOXES WILL BE RATED TO HOLD AT LEAST 50 POUNDS PER N.E.C. 314.27 A
- 11) ALL 15 AND 20 AMP YOLT RECEPTAGLE OUTLETS REQUIRED BY N.E.C. 210.52 SHALL BE LISTED AS TAMPER RESISTANT
- 12) ALL STANDARD NON-LOCKING RECEPTACLE OUTLETS MOUNTED IN DAMP OR MET LOCATIONS SHALL HAVE AN IN-USE TYPE COVER AND SHALL BE LISTED WEATHER RESISTANT
- 13) LIGHTING SHALL BE PROVIDED TO ADEQUATELY LIGHT EACH STAIRWAY PER OBBC WITH CONTROL SWITCHES @ THE TOP AND BOTTOM OF EACH STAIRWAY CONSISTING OF (6) TREADS OR MORE
- 14) 120 YOLT INTERCONNECTED SMOKE DETECTORS SHALL BE INSTALLED ON EACH FLOOR AND EACH BEDROOM AND OUTSIDE EACH BEDROOM WITHIN 15 FEET OF THE BEDROOM DOOR


ALL OUTLETS & SMITCHES ARE ARC FAULT PROTECTED

ALL KITCHEN-BATH-GARAGE-LAUNDRY RM. AND EXTERIOR OUTLETS ARE GFCI PROTECTED

FINAL FIXTURE LAYOUT, QUANTITY AND TYPE TO BE DETERMINED ON SITE WITH THE BUYER AND ELECTRICAL CONTRACTOR

ELECTRICAL LEGEND

- RECESSED CAN LIGHT
- CEILING FIXTURE
- CEILING EXHAUST FAN CEILING EXHAUST FAN
 - CEILING FAN W/LIGHT
- SMOKE DETECTOR
- PHOTOELECTRIC/IONIZATION SMOKE DETECTOR
- (CD)
- PHOTOELECTRIC CARBON MONOXIDE DETECTOR

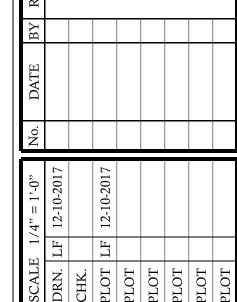



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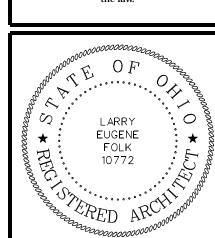
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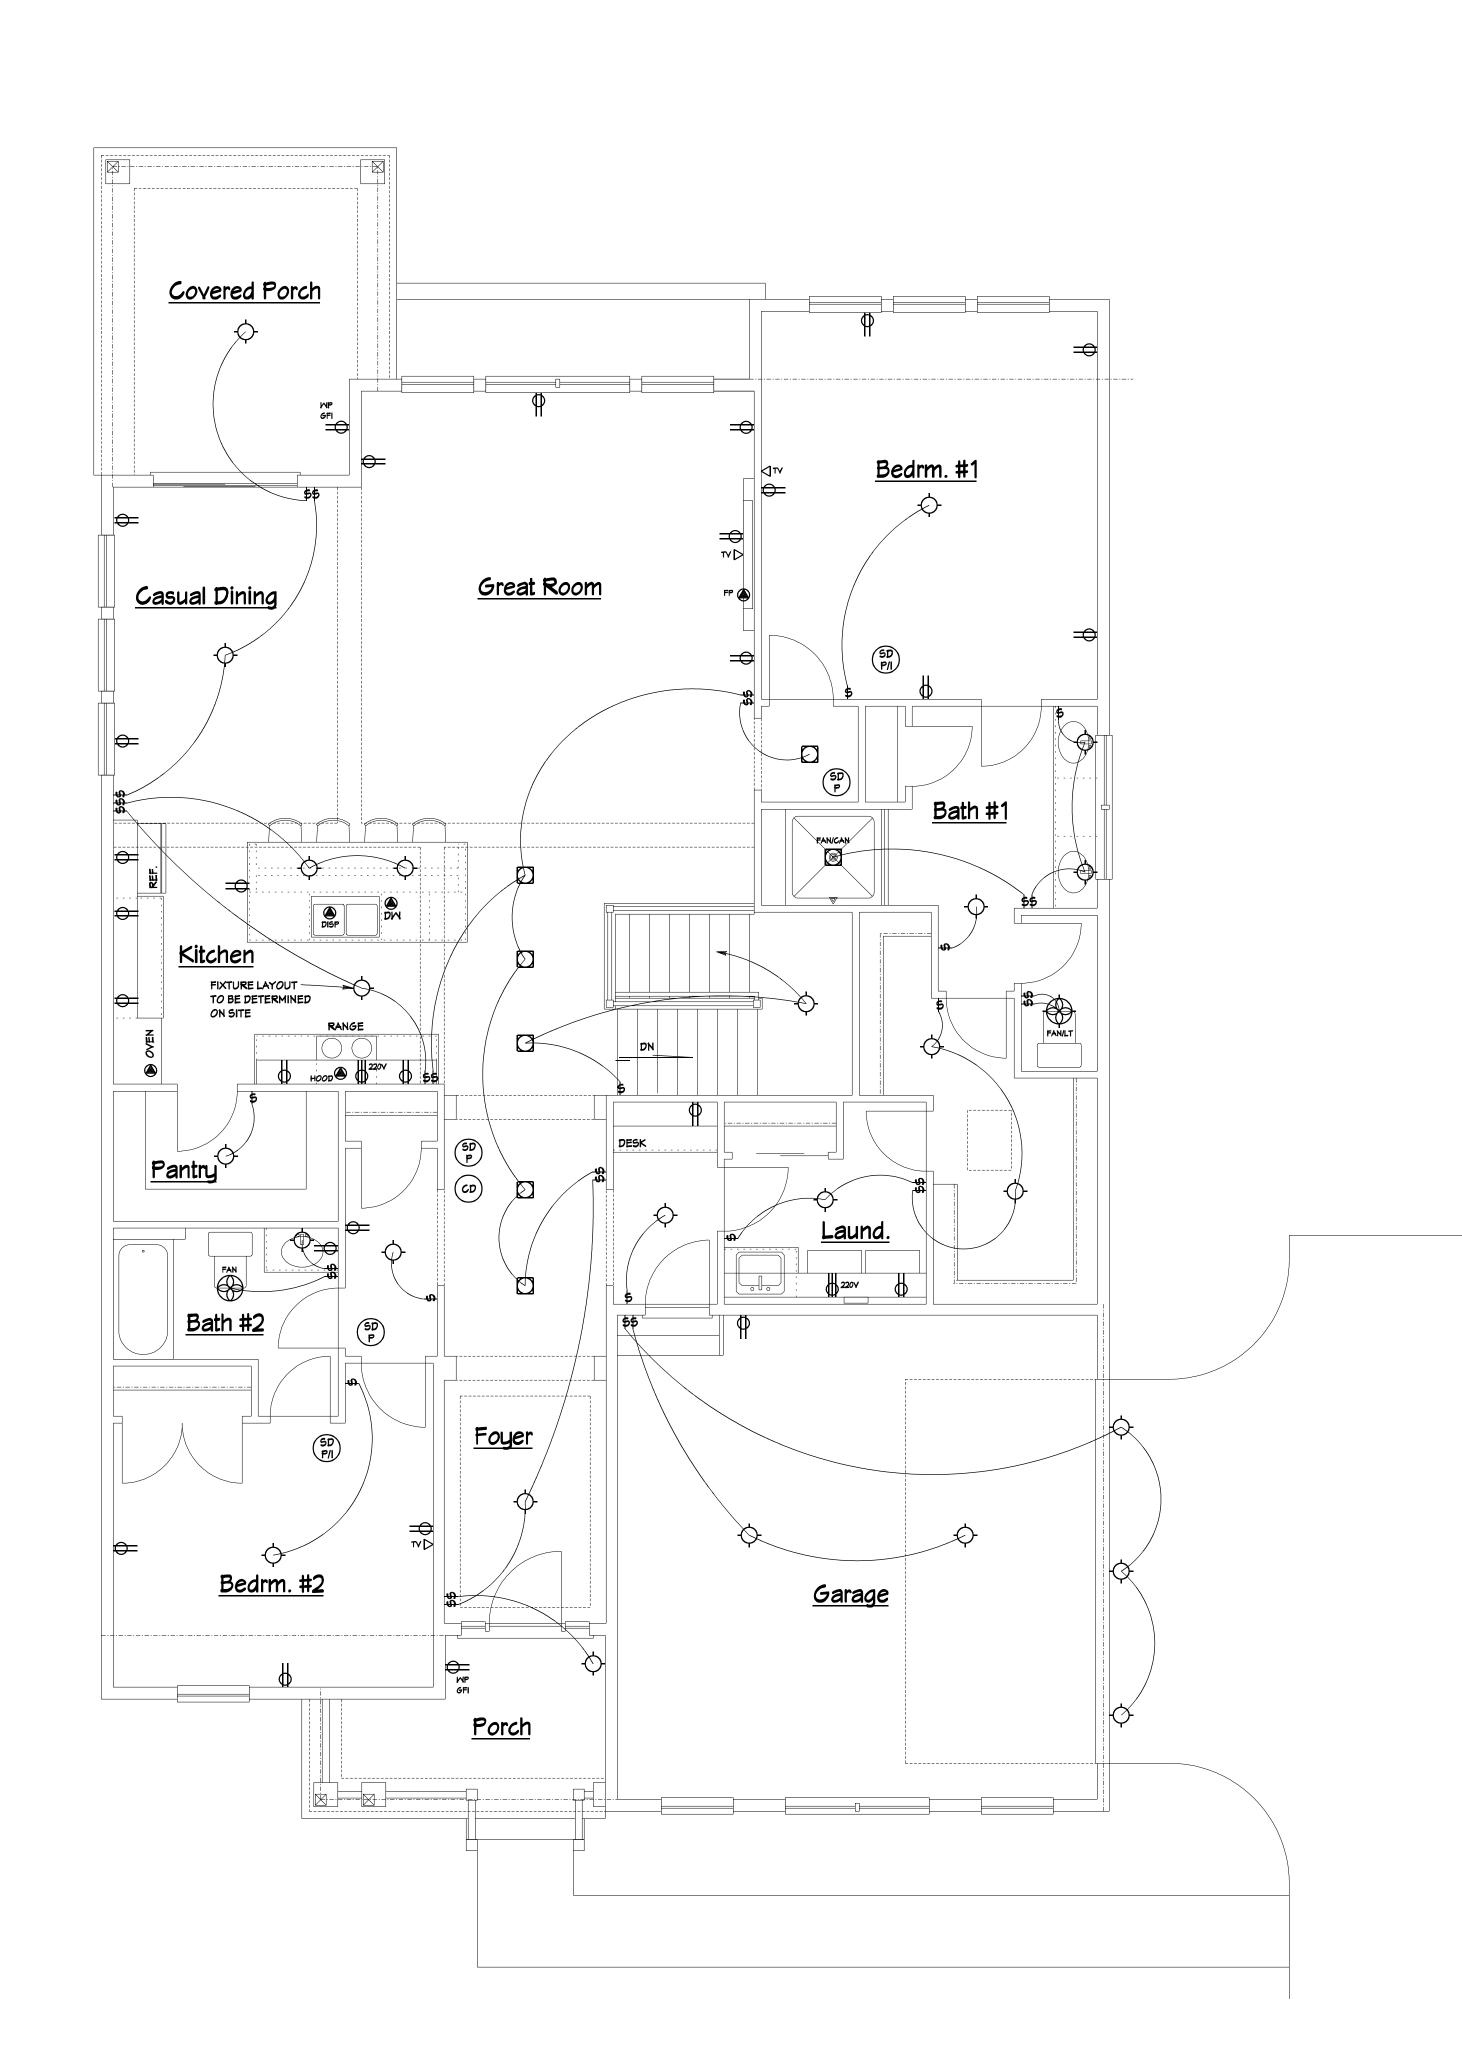
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Spec. Residence 7221 Craigens Court Lot #4 Britonwood

Job No. Sheet No. **E-2** 2017-129



ELECTRICAL NOTES

- 1) ALL ELECTRICAL WIRING TO BE INSTALLED PER N.E.C. 2014
- ELECTRICAL SERVICE LOAD SHALL BE CALCULATED PER N.E.C. ARTICLE 220
- 3) GENERAL USE OUTLETS SHALL BE INSTALLED PER N.E.C. 210.52
- 4) THERE SHALL BE AT LEAST (2)-20 AMP SMALL APPLIANCE CIRCUITS TO FEED ALL WALL AND

FLOOR OUTLETS IN THE KITCHEN, PANTRY,

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- 7) THERE SHALL BE AT LEAST (1)-20 AMP CIRCUIT TO SUPPLY THE LAUNDRY ROOM PER N.E.C. 210.10 G(2) AND 210.52 F
- 8) ALL RECEPTACLE OUTLETS IN UNFINISHED BASEMENTS, GARAGES AND ON THE EXTERIOR OF THE HOUSE SHALL BE GFCI PROTECTED PER N.E.C. 210.8
- 4) ALL 120 VOLT 15 AND 20 AMP BRANCH CIRCUITS SUPPLYING OUTLETS INSTALLED IN: FAMILY RM, DINING RM, LIVING RM, PARLOR, LIBRARY, DEN, BEDROOMS, SUN ROOM, REC ROOM, CLOSET, HALLWAY OR SMALLER ROOMS SHALL BE ARC FAULT PROTECTED PER N.E.C. 210.12 B
- 10) ALL CEILING AND WALL MOUNT LIGHT BOXES WILL BE RATED TO HOLD AT LEAST 50 POUNDS PER N.E.C. 314.27 A
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- CEILING EXHAUST FAN
- CEILING FAN W/LIGHT
- SMOKE DETECTOR PHOTOELECTRIC/IONIZATION
- SMOKE DETECTOR PHOTOELECTRIC
- CARBON MONOXIDE DETECTOR CD

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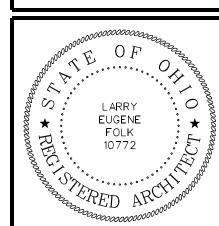
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First Floor Electric Plan

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